


CIVIL & STORMWATER WORKS for 183 AMAROO DRIVE SMITHS LAKE NSW 2428

Prepared by

WALLACE INFRASTRUCTURE DESIGN PTY LTD

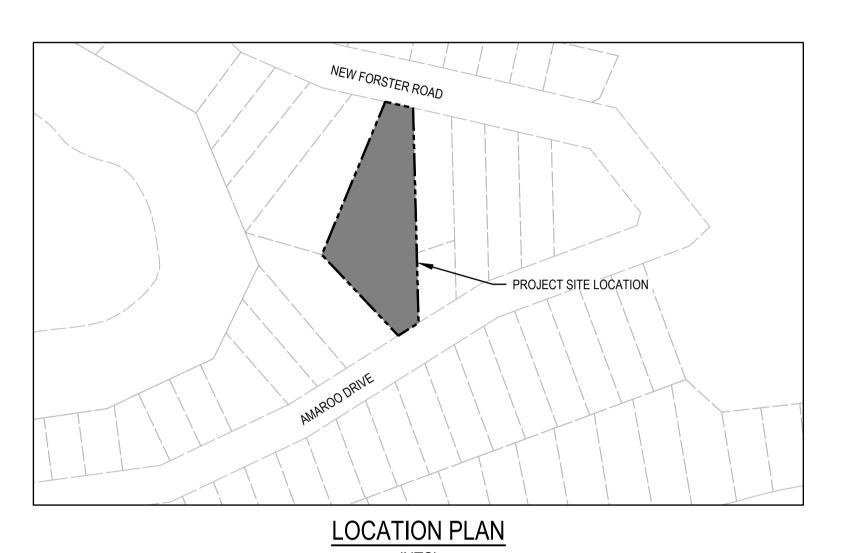

DRAWING NUMBER	DRAWING DESCRIPTION
C01.01	LEGEND, DRAWING SCHEDULE AND LOCATION PLAN
C02.01	GENERAL NOTES
C03.01	EROSION AND SEDIMENTATION CONTROL PLAN
C03.02	EROSION AND SEDIMENTATION CONTROL DETAILS
C04.01	CIVIL AND STORMWATER MANAGEMENT PLAN
C04.02	DRIVEWAY No. 1 & No. 2 LONGITUDINAL SECTION
C04.03	DRIVEWAY No. 1 CROSS-SECTIONS
C04.04	DRIVEWAY No. 2 CROSS-SECTIONS
C04.05	DRIVEWAY No. 2 CROSS-SECTIONS
C04.06	DRIVEWAY No. 2 CROSS-SECTIONS
C05.01	DRIVEWAY TYPICAL SECTIONS
C05.02	STORMWATER DETAILS

ABBREVIATIONS

A/G AGG ARCH ASP BMD C/C CICCOGCONC CTR DPD DTM ESL FHR FGL FSL FW	CONCRETE CONTROL CROWN CENTRES DIAMETER DOWNPIPE DRAWING DOWN STREAM DIGITAL TERRAIN MODEL EDGE BEAM EXISTING	GA GI IC ID IF CR IL IO KIP (MAC MINSC N NTS OF OP PPE PV PVP QTY RAC RC	LAMP POST (SURVEY) METRE MAXIMUM
--	---	---	--

REV	REVISION
RL	REDUCED LEVEL
RSJ	ROLLED STEEL JOIST
RW	RETAINING WALL
SFW	SEALED FLOOR WASTE
SHR	SHOWER
SK	KITCHEN SINK
SL	SURFACE LEVEL
SMH	SEWER MAN HOLE
SMV	SEWER MAIN VENT
SOD	SIDE OUTLET DRAIN
SP	SPRINKLER
S/S	STAINLESS STEEL
STD	STANDARD
SV	STOP VALVE
SWD	STORMWATER DRAINAGE
SWP	STORMWATER PIT
THK	THICKNESS
TOW	TOP OF WALL
TW	TRADE WASTE
TYP	TYPICAL
U/G	UNDERGROUND
UNO	UNLESS NOTED OTHERWISE UPSTREAM
U/S	VITRIFIED CLAY PIPE
VC VP	VENT PIPE
VR VR	VERTICAL RISER
WC	WATER CLOSET
WL	WATER CLOSET WATER LEVEL
WM	WATER MARK
WS	WASTE STACK

	LINE
GENERAL	
SITE BOUNDARY	
CADASTRAL BOUNDARY	
EASEMENT BOUNDARY	
EXISTING - SURVEY FEATURES	
CONTOURS	30.0
STORMWATER PIPE	
STORMWATER PIT	
TREES / SHRUBS	
ELECTRICAL CABLE - U/G	————— Е ——
ELECTRICAL CABLE - O/H	OH OH
EXISTING SEWER PIPE	— s - s - s - s —
EXISTING WATER	w - w - w - w -
EXISTING WATER (HYDRANT)	•
EXISTING WATER (STOP VALVE)	X
EXISTING TELECOM	т
EXISTING GAS	G
BUILDING FOOTPRINT	

_	<u>··· = -</u>	
	PROPOSED - UTILITIES (cont.)	
	SEWER PIPE	— s – s – s – s —
	WATER	— w- w- w- w-
	COMMUNICATIONS	т
	COMMUNICATIONS - OPTIC FIBRE	OFC
	COMMUNICATIONS PIT	
	GAS	G
	REDUNDANT	$\cdots \times \cdot \times \cdot \times \cdot \times \cdot \times \cdot \times \cdot$
	ELECTRICAL CABLE - U/G	— E – E – E – E —
	ELECTRICAL CABLE - O/H	O/H
	PROPOSED - EROSION AND SEDIM	IENT CONTROL
	SITE EXCLUSION FENCE	[X] - [X] - [X]
	STABLISED SITE ACCESS	
	SEDIMENT FENCE	
	MATERIAL STOCKPILE	())))))))))
	DIVERSION DRAIN	->->->-
	SLOPE DIRECTION	>
	MESH AND GRAVEL INLET FILTER	
	PROPOSED - ARCHITECTURE (INDI	ICATIVE ONLY)
	DWELLING NUMBER	UNIT 01
	FINISHED FLOOR LEVEL	FFL 5.00

	SY	MBOLS
PROPOSED - STORMWATER DRAI	NAGE (SWD)	PROPO
SWD PIPE	ØXXXmm uPVC X.X% GRADE, X.XXm	CONC
(INCL. DIA/GRADE/LENGTH)	A.A.// GRADE, A.AAIII	ASPHA
SWD PIPE - CHARGED (INCL. DIA/GRADE/LENGTH)	ØXXXmm uPVC CHARGE X.X% GRADE, X.XXm	SAND
SWD PIT - GRATED		EARTH
SWD - KERB INLET PIT		RIP RA
(INCLUDING LINTEL)		BUILDI
SWD PIT - JUNCTION		TIMBE
SWD LABEL	PIT XX SUR: XX.XXX	BLOCK
(TYPE / COVER LEVEL)	INV: XX.XXX	RETAIN
RAINWATER/REUSE TANK	OR (//////	KERB F
GROSS POLLUTANT TRAP	GPT	VEHIC
GRATED DRAIN		FENCE
INFILTRATION TRENCH		BATTE
HEADWALL		BOLLA
SUBSOIL	_>>	BOLLA
STORMWATER SWALE	->->->-	LINEMA
PIPE RISER	O XX	EXPAN
PIPE DROPPER	⊃ XX	CONTR
OVERLAND FLOW PATH	→	CONST
FINISHED GRADE LEVELS	25.758	LONGI
EXISTING GRADE LEVELS	25.710	LONGI

	PROPOSED - CIVIL	
C YYm	CONCRETE	
XXm	ASPHALTIC CONCRETE	
IARGE XXm	SAND	
	EARTH	
	RIP RAP	
	BUILDING / STRUCTURES	
	TIMBER	
	BLOCK PAVERS	
	RETAINING WALL	
	KERB RAMP	
Т	VEHICULAR CROSSING	
	FENCE	
	BATTER	-111
	BOLLARD - TYPE 1 (FIXED)	• B-T1
	BOLLARD - TYPE 2 (REMOVABLE)	• B-T2
->-	LINEMARKING - CHEVRON	
	EXPANSION JOINT	
	CONTRACTION JOINT	
	CONSTRUCTION JOINT	
•	LONGITUDINAL JOINT	

AutoCAD Civil 3D 2021

AUTOCAD CIVII 3D 2021	
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DRAWING HAS BEEN PRODUCED FOR THE	
PURPOSE OF INDICATING THE DIAGRAMMATIC	
DESIGN INTENT AND SCOPE OF WORKS	
REQUIRED FOR THE INSTALLATION OF SERVICES	
AS DETAILED, AND PERTAINED WITHIN THE	
SPECIFICATION AND SHOULD BE READ IN	
CONJUNCTION WITH THE ARCHITECTURAL	
SPECIFICATION, ASSOCIATED SPECIFICATION,	1
CODES AND STANDARDS. ALL DIMENSIONS,	1
LEVELS AND EXISTING SERVICES SHALL BE	'
INVESTIGATED AND CONFIRMED ON SITE BY THE	
SUBCONTRACTOR AND BUILDER PRIOR TO THE	

THIS DRAWING IS NOT APPRO			
2	FOR CONSTRUCTION		
1	FOR CONSTRUCTION		
REV	DESCRIPTION		

THIS	THIS DRAWING IS NOT APPROVED FOR CONSTRUCTION UNLESS ENDORSED				
					۱
2	FOR CONSTRUCTION	26.07.23	K.B.	K.B.	l '
1	FOR CONSTRUCTION	21.07.23	K.B.	K.B.	
REV	DESCRIPTION	DATE	APPV'D	ENDO'D	

)	PLANNER:
	MIDCOAST PLANNING PTY LTD
	TONY FISH
	tfish@midcoasttownplanning.com.au
	0499 612 844

HAYDEN HALSTED 183 AMAROO DRIVE SMITHS LAKE NSW 2428



LINETYPES

WALLACE INFRASTRUCTURE **DESIGN PTY LTD** PART OF WALLACE DESIGN GROUP PTY LTD

SMITHS LAKE NSW 2428

BUILDING FOOTPRINT

DRAWING TITLE: CIVIL SERVICES CIVIL WORKS for LEGEND, DRAWING SCHEDULE LOT 37, DP 237259 AND LOCATION PLAN 183 AMAROO DRIVE

DRAWING STATUS FOR CONSTRUCTION					
SCALE: ORIG. S				ORIG. SIZE	.1
DRAWN	DESIGNED	CHECKED	APPROVED	ENDORSED	DATE
M.S.	K.B.	K.B.	K.B.	K.B.	26.07.23
PROJECT No. DRAWING No.				REV	
23097	,	C01.01			2

GENERAL NOTES

- ALL CONSTRUCTION WORKS ARE TO BE CARRIED OUT IN ACCORDANCE WITH COUNCIL'S ENGINEERING REQUIREMENTS FOR DEVELOPMENTS.
- ALL DIMENSIONS, EASEMENTS AND LOTS SUBJECT TO REGISTRATION OF DEPOSITED PLAN. THESE DRAWINGS ARE TO BE READ IN CONJUNCTION WITH ALL ARCHITECTURAL AND CONSULTANT'S DRAWINGS AND SPECIFICATIONS, AND OTHER WRITTEN REPORTS (e.g. GEOTECHNICAL, ARBORIST, ENVIRONMENTAL, ETC.). ANY DISCREPANCY SHALL BE REFERRED TO THE ENGINEER BEFORE PROCEEDING WITH ANY WORKS.
- ALL LEVELS SHALL BE OBTAINED FROM ESTABLISHED BENCH MARKS AS DIRECTED BY THE SUPERVISOR.
- THE DEVELOPER, SHALL ENSURE ALL ASSOCIATED DOCUMENTATION (GEOTECHNICAL, LANDSCAPE, ARCHITECTURAL, ELECTRICAL, TELECOM, GAS ETC.) HAS BEEN APPROVED FOR CONSTRUCTION BEFORE COMMENCING ANY WORKS
- THE CONTRACTOR IS RESPONSIBLE FOR THE LOCATION, PROTECTION AND ADJUSTMENT TO ALL IN GROUND AND ABOVE GROUND SERVICES. SEE HUNTER WATER'S NOTICE OF REQUIREMENTS.
- EROSION CONTROL MEASURES, DEVICES, SILT TRAPS. ETC. ARE TO BE INSTALLED BEFORE ANY SITE DISTURBANCE IN ACCORDANCE WITH COUNCIL INSPECTORS REQUIREMENTS AND SITE SEDIMENTATION AND EROSION CONTROL PLANS.
- IT IS THE CONTRACTORS RESPONSIBILITY TO ENSURE THAT ALL WORKS ARE CARRIED OUT IN ACCORDANCE WITH THE WORK HEALTH SAFETY ACT
- VEHICULAR ACCESS AND ALL SERVICES ARE TO BE MAINTAINED AT ALL TIMES TO ADJOINING PROPERTIES AFFECTED BY CONSTRUCTION WORKS.
- ALL WASTE OR DEMOLISHED MATERIALS SHALL BE DISPOSED OF OFF SITE TO A COUNCIL
- APPROVED SITE. ALL FEES AND CHARGES SHALL BE INCLUDED IN THE CONTRACT SUM.
- CONSTRUCTION VIBRATION TO COMPLY WITH AS2760.1-2004 AND/OR NSW DEPT OF 11. **ENVIRONMENT AND CONSERVATION NOISE REQUIREMENTS**
- EMISSIONS FROM SITE ARE NOT TO INTERFERE WITH THE AMENITY OF THE NEIGHBORHOOD.
- 13. NOISE EMISSIONS ARE TO COMPLY WITH NSW EPA NOISE CONTROL MANUAL. TIME RESTRICTIONS APPLY TO CONSTRUCTION WORKS AS FOLLOWS: 7AM TO 6PM MON-FRI; 8AM TO
- TREES & SHRUBS WHICH ARE FELLED SHALL BE SALVAGED FOR RE-USE, EITHER IN LOG FORM, OR AS A WOODCHIP MULCH FOR EROSION CONTROL AND/OR SITE REHABILITATION. NON-SALVAGEABLE MATERIAL SUCH AS ROOTS & STUMPS SHALL BE DISPOSED OF IN AN APPROVED MANNER.
- 'ESCP' REFERS TO EROSION AND SEDIMENT CONTROL PLAN, 'SWMP' REFERS TO SOIL AND WATER MANAGEMENT PLAN, AND, 'ESC' REFERS TO EROSION AND SEDIMENT CONTROL
- SEDIMENT, INCLUDES, BUT IS NOT LIMITED TO, CLAY, SILT, SAND, GRAVEL, SOIL, MUD, CEMENT AND CERAMIC WASTE.
- ANY REFERENCE TO THE BLUE BOOK REFERS TO "MANAGING URBAN STORMWATER SOILS AND CONSTRUCTION", LANDCOM, 2004.
- ANY REFERENCE TO THE IECA WHITE BOOKS (2008) REFERS TO IECA 2008, "BEST PRACTICE EROSION AND SEDIMENT CONTROL". BOOKS 1-6. INTERNATIONAL EROSION CONTROL ASSOCIATION (AUSTRALASIA), PICTON, NSW.
- 19. ANY MATERIAL DEPOSITED IN ANY CONSERVATION AREA FROM WORKS ASSOCIATED WITH THE DEVELOPMENT SHALL BE REMOVED IMMEDIATELY BY MEASURES INVOLVING MINIMAL GROUND AND/OR VEGETATION DISTURBANCES AND NO MACHINERY, OR FOLLOWING DIRECTIONS BY COUNCIL AND/OR WITHIN A TIMEFRAME ADVISED BY COUNCIL.

SURVEY NOTES

- THE EXISTING SURVEY CONDITIONS SHOWN ON THESE DRAWINGS HAVE BEEN DERIVED FROM SURVEY INFORMATION SUPPLIED BY CALCO SURVEYORS PTY LTD CONSULTING ENGINEERS DATED 8TH JUNE 2023, JOB NO. 4332.
- THE FOLLOWING SURVEY INFORMATION HAS BEEN TAKEN DIRECTLY FROM THE ORIGINAL SURVEY DOCUMENTS:

POSITION DATUM: SS 87698 MGA 56 **ORIENTATION: EASTING**: 452 766.431 6 417 596.521 NORTHING: **HEIGHT DATUM:** RL: 7.787 (AHD)

- THE INFORMATION SHOWN IS PROVIDED AS A BASIS FOR THE DESIGN. WALLACE DESIGN GROUP DOES NOT GUARANTEE THE ACCURACY OR COMPLETENESS OF THE SURVEY BASE OR ITS SUITABILITY AS A BASIS FOR CONSTRUCTION DRAWINGS.
- SHOULD DISCREPANCIES BE ENCOUNTERED DURING CONSTRUCTION BETWEEN THE SURVEY DATA AND ACTUAL FIELD DATA, CONTRACTOR SHALL CONTACT CALCO SURVEYORS PTY LTD.
- THE CONTRACTOR SHALL ARRANGE ALL SURVEY SETOUT TO BE CARRIED OUT BY A REGISTERED SURVEYOR

THE ESCP

- THE ESCP AND ITS ASSOCIATED ESC MEASURES SHALL BE CONSTANTLY MONITORED, REVIEWED AND MODIFIED AS REQUIRED TO CORRECT DEFICIENCIES. COUNCIL HAS THE RIGHT TO DIRECT CHANGES IF, IN ITS OPINION, THE MEASURES THAT ARE PROPOSED OR HAVE BEEN INSTALLED ARE INADEQUATE TO PREVENT POLLUTION.
- PRIOR TO ANY ACTIVITIES ONSITE, THE RESPONSIBLE PERSON(S) IS TO BE NOMINATED. THE RESPONSIBLE PERSON(S) SHALL BE RESPONSIBLE FOR THE ESC MEASURES ONSITE. THE NAME, ADDRESS AND 24 HOUR CONTACT DETAILS OF THE PERSON(S) SHALL BE PROVIDED TO COUNCIL IN WRITING. COUNCIL SHALL BE ADVISED WITHIN 48 HOURS OF ANY CHANGES TO THE RESPONSIBLE PERSON(S), OR THEIR CONTACT DETAILS, IN WRITING
- AT LEAST 14 DAYS BEFORE THE NATURAL SURFACE IS DISTRIBUTED IN ANY NEW STAGE, THE CONTRACTOR SHALL SUBMIT TO THE CERTIFIER A PLAN SHOWING ESC MEASURES FOR THAT STAGE. THE DEGREE OF DESIGN DETAIL SHALL BE BASED ON THE DISTRIBUTED AREA.
- AT ANY TIME. THE ESC MEASURES ONSITE SHALL BE APPROPRIATE FOR THE AREA OF DISTURBANCE AND ITS CHARACTERISTICS, INCLUDING SOIL TYPE (IN ACCORDANCE WITH THOSE REQUIRED FOR THE SITE AS PER THE DCP).
- THE IMPLEMENTATION OF THE ESCP SHALL BE SUPERVISED BY PERSONNEL WITH
- APPROPRIATE QUALIFICATIONS AND/OR EXPERIENCE IN ESC ON CONSTRUCTION SITES. THE APPROVED ESCP SHALL BE AVAILABLE ON-SITE FOR INSPECTION BY COUNCIL OFFICERS WHILE WORK ACTIVITIES ARE OCCURRING.
- THE APPROVED ESCP SHALL BE UP TO DATE AND SHOW A TIMELINE OF INSTALLATION. MAINTENANCE AND REMOVAL OF ESC MEASURES.
- ALL ESC MEASURES SHALL BE APPROPRIATE FOR THE SEDIMENT TYPE(S) OF THE SOILS ONSITE. IN ACCORDANCE WITH THE BLUE BOOK, IECA WHITE BOOKS OR OTHER CURRENT
- ADEQUATE SITE DATA, INCLUDING SOIL DATA FROM A NATA APPROVED LABORATORY, SHALL BE OBTAINED TO ALLOW FOR THE PREPARATION OF AN APPROPRIATE ESCP. AND TO ALLOW FOR THE SELECTION, DESIGN AND SPECIFICATION OF REQUIRED ESC MEASURES.

RECOGNISED INDUSTRY STANDARDS PERTAINING TO ESC FOR AUSTRALIAN CONDITIONS.

- ALL WORK SHALL BE CARRIED OUT IN ACCORDANCE WITH THE APPROVED ESCP (AS AMENDED FROM TIME TO TIME) UNLESS CIRCUMSTANCES ARISE WHERE A) COMPLIANCE WITH THE ESCP WOULD INCREASE THE POTENTIAL FOR ENVIRONMENTAL HARM B) CIRCUMSTANCES CHANGE DURING CONSTRUCTION AND THOSE CIRCUMSTANCES COULD NOT HAVE BEEN FORSEEN: OR
 - C) COUNCIL DETERMINES THAT UNACCEPTABLE OFF-SITE SEDIMENTATION IS OCCURRING AS A RESULT OF A LAND-DISTURBING ACTIVITY. IN EITHER CASE, THE PERSON(S) RESPONSIBLE MAY BE REQUIRED TO TAKE ADDITIONAL, OR ALTERNATIVE PROTECTIVE ACTION, AND/OR UNDERTAKE REASONABLE RESTORATION WORKS WITHIN THE TIMEFRAME SPECIFIED BY THE COUNCIL.
- ADDITIONAL ESC MEASURES SHALL BE IMPLEMENTED, AND A REVISED ESCP SUBMITTED FOR APPROVAL TO THE CERTIFIER (WITHIN 5 BUSINESS DAYS OF AN SUCH AMENDMENTS) IN THE **EVENT THAT:**
 - A) THERE IS A HIGH PROBABILITY THAT SERIOUS OR MATERIAL ENVIRONMENTAL HARM MAY OCCUR AS A RESULT OF SEDIMENT LEAVING THE SITE; OR
 - B) THE IMPLEMENTED WORKS FAIL TO ACHIEVE COUNCIL'S WATER QUALITY OBJECTIVES SPECIFIED IN THESE CONDITIONS; OR
 - C) SITE CONDITIONS SIGNIFICANTLY CHANGE; OR
- D) SITE INSPECTIONS INDICATE THAT THE IMPLEMENTED WORKS ARE FAILING TO ACHIEVE THE "OBJECTIVE" OF THE ESCP.
- A COPY OF ANY AMENDED ESCP SHALL BE FORWARDED TO AN APPROPRIATE COUNCIL OFFICER, WITHIN FIVE BUSINESS DAYS OF ANY SUCH AMENDMENTS.

SITE ESTABLISHMENT INCLUDING CLEARING AND MULCHING

- NO LAND CLEARING SHALL BE UNDERTAKEN UNLESS PRECEDED BY THE INSTALLATION OF ADEQUATE DRAINAGE AND SEDIMENT CONTROL MEASURES. UNLESS SUCH CLEARING IS REQUIRED FOR THE PURPOSE OF INSTALLING SUCH MEASURES. IN WHICH CASE, ONLY THE MINIMUM CLEARING REQUIRED TO INSTALL SUCH MEASURES SHALL OCCUR.
- BULK TREE CLEARING AND GRUBBING OF THE SITE SHALL BE IMMEDIATELY FOLLOWED BY SPECIFIED TEMPORARY EROSION CONTROL MEASURES (E.G. TEMPORARY GRASSING OR MULCHING) PRIOR TO THE COMMENCEMENT OF EACH STAGE OF CONSTRUCTION WORKS.
- TREES AND VEGETATION CLEARED FROM THE SITE SHALL BE MULCHED ONSITE WITHIN 7 DAYS OF CLEARING.
- APPROPRIATE MEASURES SHALL BE UNDERTAKEN TO CONTROL ANY DUST ORIGINATING DUE TO THE MULCHING OF VEGETATION ONSITE.
- ALL OFFICE FACILITIES AND OPERATIONAL ACTIVITIES SHALL BE LOCATED SUCH THAT ANY EFFLUENT. INCLUDING WASH-DOWN WATER. CAN BE TOTALLY CONTAINED AND TREATED WITHIN THE SITE.
- ALL REASONABLE AND PRACTICABLE MEASURES SHALL BE TAKEN TO ENSURE STORMWATER RUNOFF FROM ACCESS ROADS AND STABILISED ENTRY/EXIT SYSTEMS DRAINS TO AN APPROPRIATE SEDIMENT CONTROL DEVICE.
- SITE EXIT POINTS SHALL BE APPROPRIATELY MANAGED TO MINIMISE THE RISK OF SEDIMENT BEING TRACKED ONTO SEALED, PUBLIC ROADWAYS.
- STORMWATER RUNOFF FROM ACCESS ROADS AND STABILIZED ENTRY/EXIT POINTS SHALL DRAIN TO AN APPROPRIATE SEDIMENT CONTROL DEVICE.
- THE APPLICANT SHALL ENSURE AN ADEQUATE SUPPLY OF ESC, AND APPROPRIATE POLLUTION CLEAN-UP MATERIALS ARE AVAILABLE ON-SITE AT ALL TIMES.
- ALL TEMPORARY EARTH BANKS, FLOW DIVERSION SYSTEMS, AND SEDIMENT BASIN 10. EMBANKMENTS SHALL BE MACHINE-COMPACTED, SEEDED AND MULCHED WITHIN 10 DAYS OF FORMATION FOR THE PURPOSE OF ESTABLISHING A VEGETATIVE COVER, OR LINED APPROPRIATELY.
- SEDIMENT DEPOSITED OFF SITE AS A RESULT OF ON-SITE ACTIVITIES SHALL BE COLLECTED AND THE AREA CLEANED/REHABILITATED AS SOON AS REASONABLE AND PRACTICABLE.
- CONCRETE WASTE AND CHEMICAL PRODUCTS INCLUDING PETROLEUM AND OIL-BASED PRODUCTS. SHALL BE PREVENTED FROM ENTERING ANY INTERNAL OR EXTERNAL WATER BODY. OR ANY EXTERNAL DRAINAGE SYSTEM, EXCLUDING THOSE ON-SITE WATER BODIES SPECIFICALLY DESIGNED TO CONTAIN AND/OR TREAT SUCH MATERIAL. APPROPRIATE

- MEASURES SHALL BE INSTALLED TO TRAP THESE MATERIALS ONSITE.
- BRICK. TILE OR MASONRY CUTTINGS SHALL BE CARRIED OUT ON A PERVIOUS SURFACE (E.G. GRASS OR OPEN SOIL) AND IN SUCH A MANNER THAT ANY RESULTING SEDIMENT-LADEN RUNOFF IS PREVENTED FROM DISCHARGING INTO A GUTTER, DRAIN OR WATER. APPROPRIATE MEASURES SHALL BE INSTALLED TO TRAP THESE MATERIALS ONSITE.
- NEWLY SEALED HARD-STAND AREAS (E.G. ROADS, DRIVEWAYS AND CAR PARKS) SHALL BE SWEPT THOROUGHLY AS SOON AS PRACTICABLE AFTER SEALING/SURFACING TO MINIMISE THE RISK OF COMPONENTS OF THE SURFACING COMPOUND ENTERING THE STORMWATER DRAINS.
- STOCKPILES OF ERODIBLE MATERIAL SHALL BE PROVIDED WITH AN APPROPRIATE PROTECTIVE COVER (SYNTHETIC OR ORGANIC) IF THE MATERIALS ARE LIKELY TO BE STOCKPILED FOR MORE THAN 10 DAYS.
- 16. STOCKPILES, TEMPORARY OR PERMANENT, SHALL NOT BE LOCATED IN AREAS IDENTIFIED AS NO-GO ZONES (INCLUDING, BUT NOT LIMITED TO, RESTRICTED ACCESS AREAS, BUFFER ZONES, OR AREAS OF NON-DISTURBANCE) ON THE ESCP.
- 17. NO MORE THAN 150m OF STORMWATER, SEWER LINE OR OTHER SERVICE TRENCH SHALL BE TO OPEN AT ANY ONE TIME.
- SITE SPOIL SHALL BE LAWFULLY DISPOSED OF IN A MANNER THAT DOES NOT RESULT IN ONGOING SOIL EROSION OR ENVIRONMENTAL HARM.
- 19. WHEREVER REASONABLE AND PRACTICABLE, STORMWATER RUNOFF ENTERING THE SITE FROM EXTERNAL AREAS, AND NON-SEDIMENT LADEN (CLEAN) STORMWATER RUNOFF ENTERING A WORK AREA OR AREA OF SOIL DISTURBANCE, SHALL BE DIVERTED AROUND OR THROUGH THAT AREA IN A MANNER THAT MINIMISES SOIL EROSION AND THE CONTAMINATION OF THAT WATER FROM ALL DISCHARGES UP TO THE SPECIFIED DESIGN STORM DISCHARGE.

SITE MANAGEMENT INCLUDING DUST

- PRIORITY SHALL BE GIVEN TO THE PREVENTION, OR AT LEAST THE MINIMISATION, OF SOIL EROSION, RATHER THAN THE TRAPPING OF DISPLACED SEDIMENT, SUCH A CLAUSE SHALL NOT REDUCE THE RESPONSIBILITY TO APPLY AND MAINTAIN, AT ALL TIMES, ALL NECESSARY ESC
- MEASURES USED TO CONTROL WIND EROSION SHALL BE APPROPRIATE FOR THE LOCATION AND PREVENT SOIL EROSION AND EMISSIONS FROM SITE AT ALL TIMES. INCLUDING WORKING HOURS, OUT OF HOURS, WEEKENDS, PUBLIC HOLIDAYS, AND DURING ANY OTHER SHUTDOWN PERIODS.
- THE APPLICATION OF LIQUID OR CHEMICAL-BASED DUST SUPPRESSION MEASURES SHALL ENSURE THAT SEDIMENT-LADEN RUNOFF RESULTING FROM SUCH MEASURES DOES NOT CREATE A TRAFFIC OR ENVIRONMENTAL HAZARD.
- ALL CUT AND FILL EARTH BATTERS LESS THAN 3m IN ELEVATION SHALL BE TOPSOILED, AND GRASS SEEDED/HYDROMULCHED WITHIN 10 DAYS OF COMPLETION OF GRADING IN CONSULTATION WITH COUNCIL.
- ALL DISTURBED AREAS SHALL BE STABILISED IN ACCORDANCE WITH TIMELINES IN THE BLUE
- ALL REASONABLE AND PRACTICABLE MEASURES SHALL BE TAKEN TO PREVENT, OR AT LEAST
- MINIMISE, THE RELEASE OF SEDIMENT FROM THE SITE. SUITABLE ALL-WEATHER MAINTENANCE ACCESS SHALL BE PROVIDED TO ALL SEDIMENT CONTROL DEVICES.
- SEDIMENT CONTROL DEVICES OTHER THAN SEDIMENT BASINS SHALL BE DE-SILTED AND MADE FULLY OPERATIONAL AS SOON AS REASONABLE AND PRACTICABLE AFTER A SEDIMENT-PRODUCING EVENT, WETHER NATURAL OR ARTIFICIAL, IF THE DEVICES SEDIMENT RETENTION CAPACITY FALLS BELOW 75% OF ITS DESIGNED RETENTION CAPACITY.
- ALL EROSION AND SEDIMENT CONTROL MEASURES, INCLUDING DRAINAGE CONTROL MEASURES. SHALL BE MAINTAINED IN PROPER WORKING ORDER AT ALL TIMES DURING THEIR OPERATION LIVES.
- WASHING/FLUSHING OF SEALED ROADWAYS SHALL ONLY OCCUR WHERE SWEEPING HAS FAILED TO REMOVE SUFFICIENT SEDIMENT AND THERE IS A COMPELLING NEED TO REMOVE THE REMAINING SEDIMENT (E.G. FOR SAFETY REASONS). IN SUCH CIRCUMSTANCES. ALL REASONABLE AND PRACTICABLE SEDIMENT CONTROL MEASURES SHALL BE USED TO PREVENT, OR AT LEAST MINIMISE. THE RELEASE OF SEDIMENT INTO THE RECEIVING WATERS, ONLY THOSE MEASURES THAT WILL NOT CAUSE SAFETY AND PROPERTY FLOODING ISSUES SHALL BE EMPLOYED. SEDIMENT REMOVED FROM ROADWAYS SHALL BE DISPOSED OF IN A LAWFUL MANNER THAT DOES NOT CAUSE ONGOING SOIL EROSION OR ENVIRONMENTAL HARM.
- SEDIMENT REMOVED FROM SEDIMENT TRAPS AND PLACES OF SEDIMENT DEPOSITIONS SHALL BE DISPOSED OF IN A LAWFUL MANNER THAT DOES NOT CAUSE ONGOING SOIL EROSION OR ENVIRONMENTAL HARM.

REVEGETATION/STABILISATION

- TEMPORARY STABILISATION MAY BE ATTAINED USING VEGETATION, NON WETTABLE SOIL POLYMERS, OR PNEUMATICALLY APPLIED EROSION CONTROLS.
- ALL CUT AND FILL EARTH BATTERS LESS THAN 3m IN ELEVATION SHALL BE TOPSOILED, AND GRASS SEEDED/HYDROMULCHED WITHIN 10 DAYS OF COMPLETION OF GRADING IN CONSULTATION WITH COUNCIL
- AT THE COMPLETION OF FORMATION IN ANY SECTION, ALL DISTRIBUTED AREAS SHALL BE STABILISED IN ACCORDANCE WITH TIME LINES IN THE BLUE BOOK
- THE COUNCIL SEED MIX SHALL BE USED UNLESS STATED ON THE ESCP/SWMP.
- THE PH LEVEL OF TOPSOIL SHALL BE APPROPRIATE TO ENABLE ESTABLISHMENT AND GROWTH OF SPECIFIED VEGETATION PRIOR TO INITIATING THE ESTABLISHMENT OF VEGETATION.
- NON REWETTABLE BINDER SHALL BE USED IN ALL HYDROMULCH/HYDROSEED POLYMER MIXES ON SLOPES OR WORKS ADJACENT TO A WATER COURSE.
- SOIL AMELIORANTS SHALL BE ADDED TO THE SOIL IN ACCORDANCE WITH AN APPROVED LANDSCAPE PLAN, VEGETATION MANAGEMENT PLAN, AND/OR SOIL ANALYSIS.
- PROCEDURES FOR INITIATING A SITE SHUTDOWN, WHETHER PROGRAMMED OR UN-PROGRAMMED, SHALL INCORPORATE REVEGETATION OF ALL SOIL DISTURBANCES UNLESS OTHERWISE APPROVED BY COUNCIL. THE STABILISATION WORKS SHALL NOT RELY UPON THE LONGEVITY OF NON-VEGETATED EROSION CONTROL BLANKETS. OR TEMPORARY SOIL BINDERS.

SITE MONITORING AND MAINTENANCE

C) WITHIN 24 HOURS OF EXPECTED RAINFALL; AND

- THE APPLICANT SHALL ENSURE THAT APPROPRIATE PROCEDURES AND SUITABLY QUALIFIED PERSONNEL ARE ENGAGED TO PLAN AND CONDUCT SITE INSPECTIONS AND WATER QUALITY
- MONITORING THROUGHOUT THE CONSTRUCTION AND MAINTENANCE PHASE. ALL ESC MEASURES SHALL BE INSPECTED AND ANY MAINTENANCE UNDERTAKEN: A) AT LEAST DAILY (WHEN WORKS IS OCCURRING ON-SITE); AND B) AT LEAST WEEKLY (WHEN WORKS IS NOT OCCURRING ON-SITE) AND
- D) WITHIN 18 HOURS OF A RAINFALL EVENT THAT CAUSES RUNOFF ON THE SITE. WRITTEN RECORDS SHALL BE KEPT ONSITE OF ESC MONITORING AND MAINTENANCE ACTIVITIES CONDUCTED DURING THE CONSTRUCTION AND MAINTENANCE PERIODS, AND BE
- AVAILABLE TO COUNCIL OFFICERS ON REQUEST. ALL ENVIRONMENTAL RELEVANT INCIDENTS SHALL BE RECORDED IN A FIELD LOG THAT SHALL REMAIN ACCESSIBLE TO ALL RELEVANT REGULATORY AUTHORITIES.
- ALL WATER QUALITY DATA, INCLUDING DATES OF RAINFALL, DATES OF TESTING, TESTING RESULTS AND DATES OF WATER RELEASE, SHALL BE KEPT IN AN ON-SITE REGISTER. THE REGISTER IS TO BE MAINTAINED UP TO DATE FOR THE DURATION OF THE APPROVED WORKS AND BE AVAILABLE ON-SITE FOR INSPECTION BY ALL RELEVANT REGULATORY AUTHORITIES ON
- AT NOMINATED INSTREAM WATER MONITORING SITES. A MINIMUM OF 3 WATER SAMPLES SHALL BE TAKEN AND ANALYSED, AND THE AVERAGE RESULT USED TO DETERMINE QUALITY

STORMWATER NOTES

- THESE DRAWINGS ARE TO BE READ IN CONJUNCTION WITH RELEVANT ARCHITECTURAL
- ALL WORKS ARE TO BE IN ACCORDANCE WITH AS3500, COUNCIL'S DEVELOPMENT CONTROL PLAN AND PROPRIETARY MANUFACTURERS RECOMMENDATIONS.
- UNLESS OTHERWISE STATED, ALL STORMWATER PIPES (INCLUDING DOWNPIPES AND RAINWATER TANK OVERFLOW PIPES) ARE TO BE uPVC SEWER GRADE, U.N.O JOINTED &
- INSTALLED TO MANUFACTURERS RECOMMENDATIONS. ALL uPVC STORMWATER LINES TO HAVE ALL JOINTS, INC. DOWNPIPE CONNECTIONS, FULLY SOLVENT WELDED, INCLUDING ANY CHARGED LINES.
- CONNECT DOWNPIPES AS REQUIRED TO NOMINATED HARVESTING TANK IN ACCORDANCE WITH APPROVED DEVELOPMENT PLANS AND HYDRAULIC ENGINEERS DESIGN.
- ALL LEVELS ARE DATUM AHD.
- ALL LEVELS ARE FINISHED PAVEMENT OR LAWN LEVELS.
- CONTRACTOR TO ALLOW FOR ALL PIPE SUPPORT SYSTEM TO SOFFIT AS PER MANUFACTURERS
- ALL CONCRETE TO BE MANUFACTURED AND SUPPLIED IN ACCORDANCE WITH AS1379.
- AT COUNCILS DISCRETION, ALL CONCRETE CAN BE SUBJECT TO PROJECT ASSESSMENT AND **TESTING TO AS1379**
- MINIMUM PIPE COVERS TO BE IN ACCORDANCE WITH AS3500.
- PITS TO BE FILLED ACCORDINGLY TO MEET INVERTS AS NEEDED.
- CONTRACTOR TO CONFIRM ALL LEVELS PRIOR TO CONSTRUCTION. ANY DISCREPANCIES ARE TO BE IMMEDIATELY REPORTED TO WALLACE DESIGN GROUP

SUBSOIL DRAINAGE NOTES

- CONSTRUCTION SHALL BE IN ACCORDANCE WITH COUNCIL'S CONSTRUCTION SPECIFICATIONS FOR SUBSURFACE DRAINAGE.
- SUBSOIL PIPE TO BE Ø100 SLOTTED PVC OR CORRUGATED CIRCULAR PLASTIC PIPE AND ENCLOSED IN SEAMLESS FILTER FABRIC SOCK
- SUBSOIL DRAINS SHALL CONSIST OF A 300 (MINIMUM) WIDE TRENCH, BACKFILLED WITH 7 OR 10mm AGGREGATE AND WRAPPED IN BIDIM A12 GEOTEXTILE FABRIC OR SIMILAR, LAPPED AT THE TOP. DEPTH OF TRENCH TO EXTEND 450 (MINIMUM) IN ROCK OR 600 (MINIMUM) IN EARTH BELOW FINISHED SUB-GRADE LEVEL. INVERT OF TRENCH SHOULD ALSO BE LOWER THAN THE INVERT OF ANY SERVICE CROSSINGS.

ROAD/DRIVEWAY PAVEMENT NOTES

THE PAVEMENT DESIGN RECOMMENDATIONS SHOWN ON THESE DRAWINGS ARE INDICATIVE ONLY, AND ARE TO BE CONFIRMED BEFORE CONSTRUCTION CERTIFICATE STAGE BY A QUALIFIED AND CERTIFIED GEO-TECHNICAL ENGINEER.

RETAINING WALL NOTES

ALL RETAINING WALLS SHOWN ON THESE PLANS SHALL BE DESIGNED BY A REGISTERED PROFESSIONAL STRUCTURAL ENGINEERING AT TIME OF CONSTRUCTION CERTIFICATE STAGE

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MMENCEMENT OF ANY WORKS

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TONY FISH

MIDCOAST PLANNING PTY LTD tfish@midcoasttownplanning.com.au 0499 612 844

HAYDEN HALSTED 183 AMAROO DRIVE SMITHS LAKE NSW 2428



WALLACE INFRASTRUCTURE DESIGN PTY LTD

PART OF WALLACE DESIGN GROUP PTY LTD PO BOX 23, CHARLESTOWN, NSW 2290 phone: (02) 49 294 109


183 AMAROO DRIVE

CIVIL WORKS for LOT 37, DP 237259


SMITHS LAKE NSW 2428

DRAWING TITLE: **CIVIL SERVICES GENERAL NOTES**

DRAWING STATUS FOR CONSTRUCTION ORIG. SIZE SCALE: N.T.S. Α1 DRAWN DESIGNED CHECKED APPROVED ENDORSED DATE M.S. K.B. K.B. 26.07.23 K.B. K.B. PROJECT No. 23097 C02.01

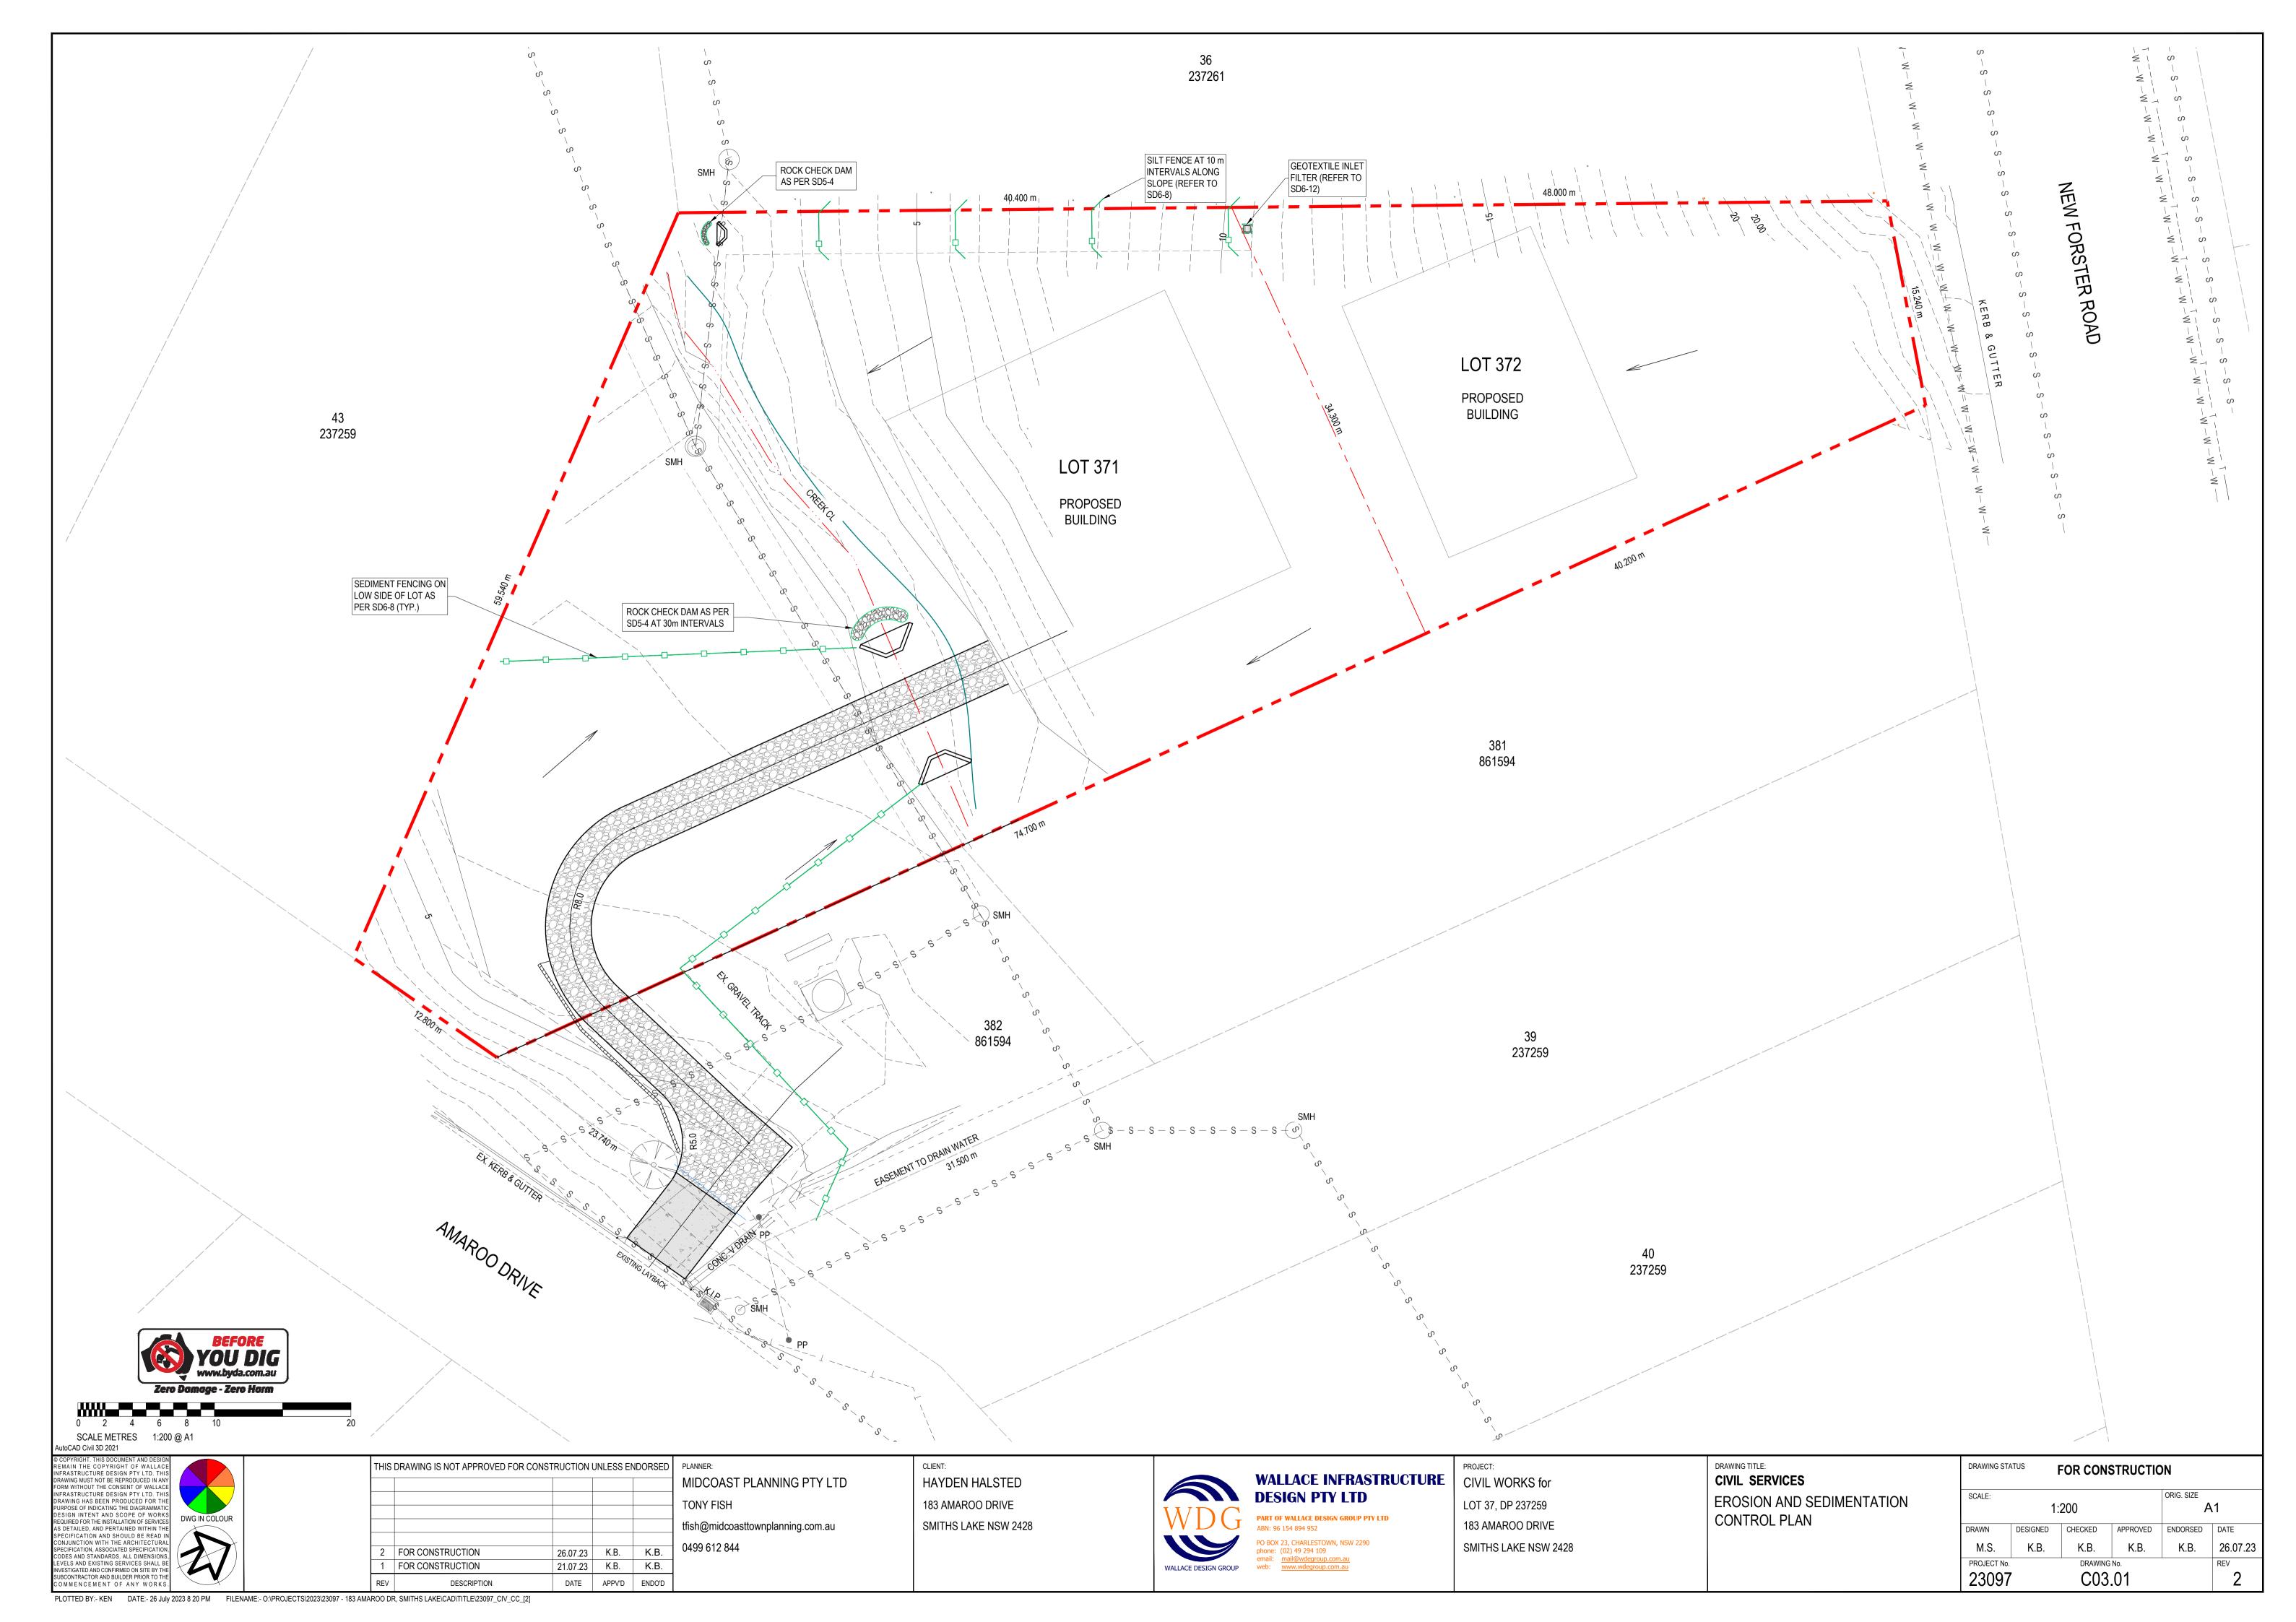


ALL EROSION & SEDIMENTATION CONTROL (ESC) PLAN DETAILS SHOWN ARE FROM "MANAGING URBAN STORMWATER - SOILS AND CONSTRUCTION", LANDCOM, 2004. DETAILS, ALTHOUGH NOT SPECIFICALLY IDENTIFIED FOR USE ON THE ESC PLAN (SHEET C03.01), ARE PROVIDED IN THE EVENT ADDITIONAL CONTROLS ARE REQUIRED TO MINIMISE ON-SITE EROSION DURING THE COURSE OF CONSTRUCTION. IF AN ESC DETAIL IS NOT SHOWN, CONTRACTOR SHALL REFER TO THE ABOVE REFERENCED GUIDE.

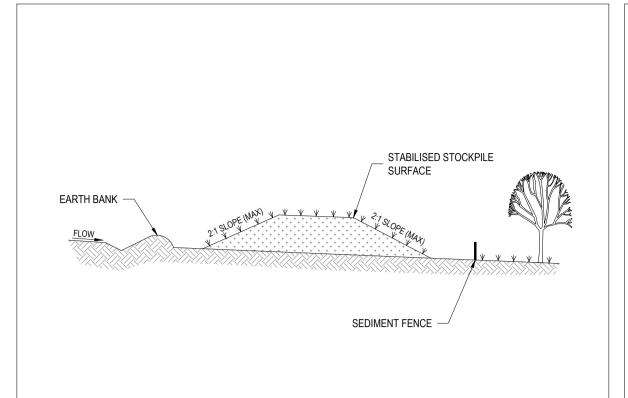

CONSTRUCTION NOTES:

- PLACE STOCKPILES MORE THAN 2 (PREFERABLY 5) METERS FROM EXISTING VEGETATION, CONCENTRATED WATER FLOW, ROADS AND HAZARD AREAS.
- CONSTRUCT ON THE CONTOUR AS LOW, FLAT, ELONGATED MOUNDS.
- WHERE THERE IS SUFFICIENT AREA, TOPSOIL STOCKPILES SHALL BE LESS THAN 2 METERS IN HEIGHT.
- WHERE THEY ARE TO BE IN PLACE FOR MORE THAN 10 DAYS, STABILISE FOLLOWING THE APPROVED
- ESCP OR SWMP TO REDUCE THE C-FACTOR TO LESS THAN 0.10.
- CONSTRUCT EARTH BANKS (STANDARD DRAWING 5-5) ON THE UPSLOPE SIDE TO DIVERT WATER AROUND STOCKPILES AND SEDIMENT FENCES (STANDARD DRAWING 6-8) 1 TO 2 METERS DOWNSLOPE.


STOCKPILES

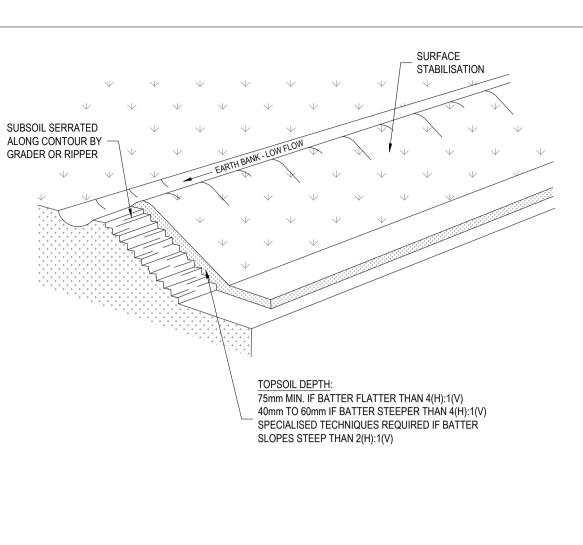

CONSTRUCTION NOTES:

REPLACING TOPSOIL

- SCARIFY THE GROUND SURFACE ALONG THE LINE OF THE CONTOUR TO A DEPTH OF 50mm TO 100mm TO BREAK UP ANY HARDSETTING SURFACES AND TO PROVIDE A GOOD BOND BETWEEN THE RESPREAD MATERIAL AND SUBSOIL.
- ADD SOIL AMELIORANTS AS REQUIRED BY THE ESCP OR SWMP.
- RIP TO A DEPTH OF 300mm IF COMPACTED LAYERS OCCUR.
- 4. WHERE POSSIBLE, REPLACE TOPSOIL TO A DEPTH OF 40 TO 60mm ON LANDS WHERE THE SLOPE EXCEEDS 4(H):1(V) AND TO AT LEAST 75mm ON LOWER GRADIENTS.

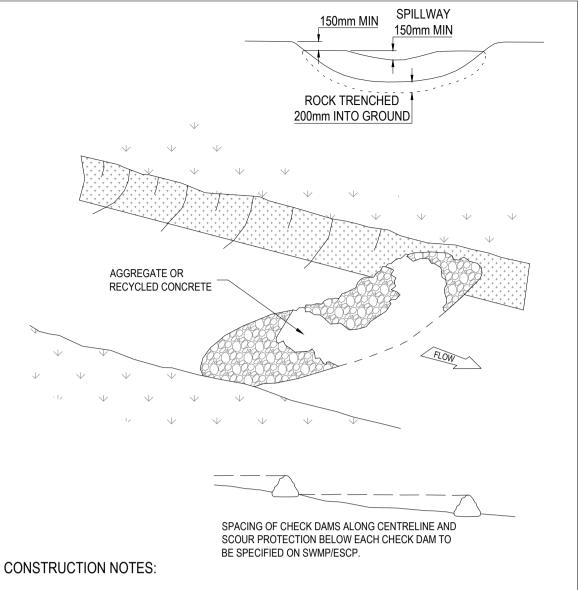

- CHECK DAMS CAN BE BUILT WITH VARIOUS MATERIALS, INCLUDING ROCKS, LOGS, SANBAGS AND STRAW BALES THE MAINTENANCE PROGRAM SHOULD ENSURE THEIR INTEGRITY IS RETAINED. ESPECIALLY WHERE CONSTRUCTED WITH STRAW BALES. IN THE CASE OF BALES, THIS MIGHT REQUIRE THEIR REPLACEMENT EACH TWO TO FOUR MONTHS.
- TRENCH THE CHECK DAM 200mm INTO THE GROUND ACROSS ITS WHOLE WIDTH. WHERE ROCK IS USED, FILL THE TRENCHES TO AT LEAST 100mm ABOVE THE GROUND SURFACE TO REDUCE THE RISK
- NORMALLY, THEIR MAXIMUM HEIGHT SHOULD NOT EXCEED 600mm ABOVE THE GULLY FLOOR. THE CENTRE SHOULD ACT AS A SPILLWAY, BEING AT LEAST 150mm LOWER THAN THE OUTER EDGE.
- SPACE THE DAMS SO THE TOE OF THE UPSTREAM DAM IS LEVEL WITH THE SPILLWAY OF THE NEXT
- DOWNSTREAM DAM.

EARTH BANK (LOW FLOW)

CONSTRUCTION NOTES:

BUILD WITH GRADIENTS BETWEEN 1 PERCENT AND 5 PERCENT.


AVOID REMOVING TREES AND SHRUBS IF POSSIBLE - WORK AROUND THEM.

ENSURE THE BANKS ARE PROPERLY COMPACTED TO PREVENT FAILURE.

ENSURE THE STRUCTURES ARE FREE OF PROJECTIONS OR OTHER IRREGULARITIES THAT COULD

BUILD THE DRAINS WITH CIRCULAR, PARABOLIC OR TRAPEZOIDAL CROSS SECTIONS, NOT V-SHAPED.

COMPLETE PERMANENT OR TEMPORARY STABILISATION WITHIN 10 DAYS OF CONSTRUCTION.

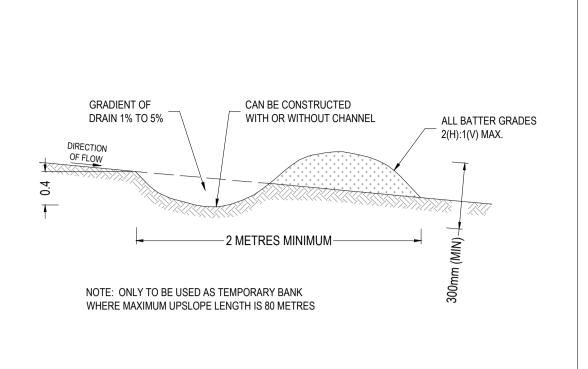

ANGLE FIRST STAKE **ELEVATION** TOWARD PREVIOUS BALE STRAW BALES TIGHTLY ABUTTING TOGETHER NYLON OR WIRE BINDINGS ├**-**1.5m TO 2m -DISTURBED AREA BALES EMBEDDED SECTION A-A 100mm INTO GROUND CONSTRUCTION NOTES:

- CONSTRUCT THE STRAW BALE FILTER AS CLOSE AS POSSIBLE TO BEING PARALLEL TO THE CONTOURS OF THE SITE.
- PLACE BALES LENGTHWISE IN A ROW WITH ENDS TIGHTLY ABUTTING. USE STRAW TO FILL ANY GAPS BETWEEN BALES. STRAWS ARE TO BE PLACED PARALLEL TO GROUND.
- ENSURE THAT THE MAXIMUM HEIGHT OF THE FILTER IS ONE BALE.

1.2m STAR PICKET


GROUND

DRIVEN 600mm INTO -

- EMBED EACH BALE IN THE GROUND 75mm TO 100mm AND ANCHOR WITH TWO 1.2m STAR PICKETS OR STAKES. ANGLE THE FIRST STAR PICKET OR STAKE IN EACH BALE TOWARDS THE PREVIOUSLY LAID BALE. DRIVE THEM 600mm INTO THE GROUND AND, IF POSSIBLE, FLUSH WITH THE TOP OF THE BALES. WHERE STAR PICKETS ARE USED AND THEY PROTRUDE ABOVE THE BALES, ENSURE THEY ARE FITTED WITH SAFETY CAPS.
- WHERE A STRAW BALE FILTER IS CONSTRUCTED DOWNSLOPE FROM A DISTURBED BATTER, ENSURE THE BALES ARE PLACED 1 TO 2 METRES DOWNSLOPE FROM THE TOE.
- ESTABLISH A MAINTENANCE PROGRAM THAT ENSURES THE INTEGRITY OF THE BALES IS RETAINED THEY COULD


REQUIRE REPLACEMENT EACH TWO TO FOUR MONTHS.

STRAW BALE FILTER

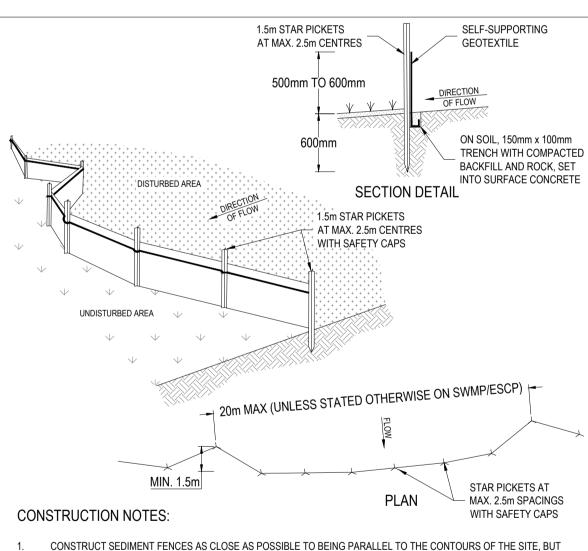

- CONSTRUCT SEDIMENT FENCES AS CLOSE AS POSSIBLE TO BEING PARALLEL TO THE CONTOURS OF THE SITE, BUT WITH SMALL RETURNS AS SHOWN IN THE DRAWING TO LIMIT THE CATCHMENT AREA OF ANY ONE SECTION. THE CATCHMENT AREA SHOULD BE SMALL ENOUGH TO LIMIT WATER FLOW IF CONCENTRATED AT ONE POINT TO 50 LITRES PER SECOND IN THE DESIGN STORM EVENT, USUALLY THE 10-YEAR EVENT.
- CUT A 150mm DEEP TRENCH ALONG THE UPSLOPE LINE OF THE FENCE FOR THE BOTTOM OF THE FABRIC TO BE
- DRIVE 1.5 METRE LONG STAR PICKETS INTO GROUND AT 2.5 METRE INTERVALS (MAX) AT THE DOWNSLOPE EDGE OF THE TRENCH. ENSURE ANY STAR PICKETS ARE FITTED WITH SAFETY CAPS.
- FIX SELF-SUPPORTING GEOTEXTILE TO THE UPSLOPE SIDE OF THE POSTS ENSURING IT GOES TO THE BASE OF THE TRENCH. FIX THE GEOTEXTILE WITH WIRE TIES OR AS RECOMMENDED BY THE MANUFACTURER. ONLY USE GEOTEXTILE SPECIFICALLY PRODUCED FOR SEDIMENT FENCING. THE USE OF SHADE CLOTH FOR THIS PURPOSE IS NOT SATISFACTORY.
- JOIN SECTIONS OF FABRIC AT A SUPPORT POST WITH A 150mm OVERLAP.
- 6. BACKFILL THE TRENCH OVER THE BASE OF THE FABRIC AND COMPACT IT THOROUGHLY OVER THE GEOTEXTILE

SEDIMENT FENCE

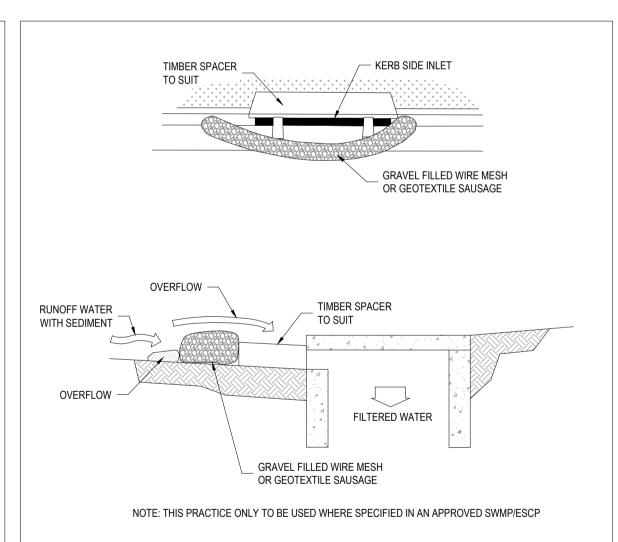


CONSTRUCTION NOTES:

- INSTALL FILTERS TO KERB INLETS ONLY AT SAG POINTS.
- FABRICATE A SLEEVE MADE FROM GEOTEXTILE OR WIRE MESH LONGER THAN THE LENGTH OF THE INLET PIT AND FILL IT WITH 25mm TO 50mm GRAVEL.
- FORM AN ELLIPTICAL CROSS-SECTION ABOUT 150mm HIGH X 400mm WIDE.
- PLACE THE FILTER AT THE OPENING LEAVING AT LEAST A 100mm SPACE BETWEEN IT AND THE KERB INLET. MAINTAIN THE OPENING WITH SPACER BLOCKS.
- FORM A SEAL WITH THE KERB TO PREVENT SEDIMENT BYPASSING THE FILTER.
- SANDBAGS FILLED WITH GRAVEL CAN SUBSTITUTE FOR THE MESH OR GEOTEXTILE PROVIDING THEY ARE PLACED SO THAT THEY FIRMLY ABUT EACH OTHER AND SEDIMENT-LADEN WATERS CANNOT PASS BETWEEN.

0499 612 844

MESH AND GRAVEL INLET FILTER

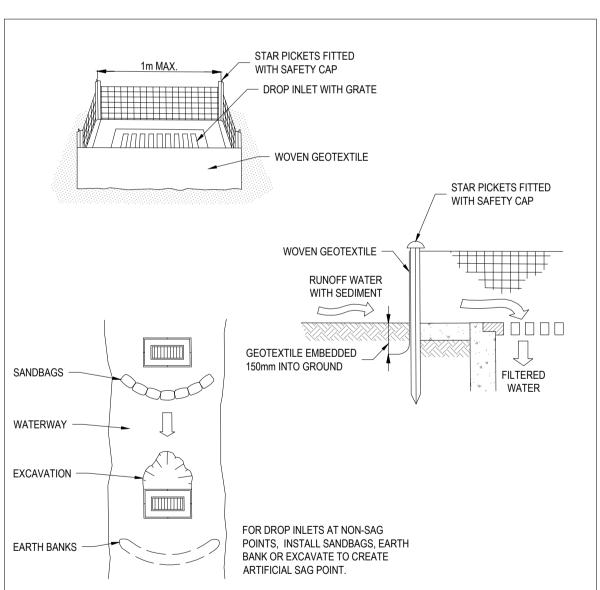


CONSTRUCTION NOTES:

ROCK CHECK DAM

- 1. FABRICATE A SEDIMENT BARRIER MADE FROM GEOTEXTILE OR STRAW BALES.
- 2. FOLLOW STANDARD DRAWING 6-7 AND STANDARD DRAWING 6-8 FOR INSTALLATION PROCEDURES FOR THE STRAW BALES OR GEOFABRIC. REDUCE THE PICKET SPACING TO 1 METRE CENTRES.
- IN WATERWAYS, ARTIFICIAL SAG POINTS CAN BE CREATED WITH SANDBAGS OR EARTH BANKS AS SHOWN IN THE
- 4. DO NOT COVER THE INLET WITH GEOTEXTILE UNLESS THE DESIGN IS ADEQUATE TO ALLOW FOR ALL WATERS TO


SD 6-11 | GEOTEXTILE INLET FILTER SD 6-12

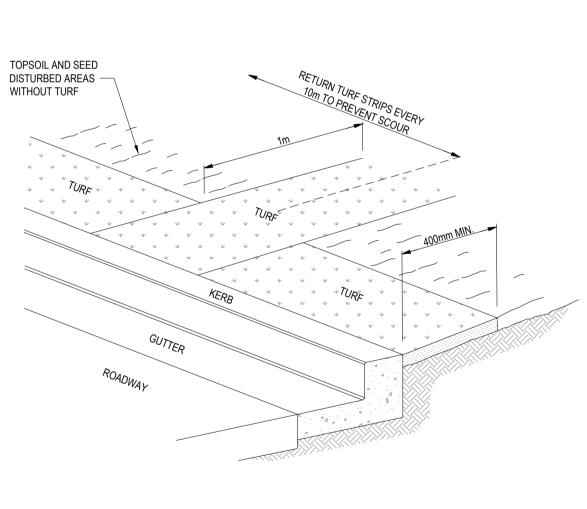

CONSTRUCTION NOTES:

- INSTALL A 400mm MINIMUM WIDE ROLL OF TURF ON THE FOOTPATH NEXT TO THE KERB AND AT THE SAME LEVEL AS THE TOP OF THE KERB AND LIGHTLY COMPACTED INTO THE TOPSOIL
- LAY 1.4 METRE LONG TURF STRIPS NORMAL TO THE KERB EVERY 10 METRES.
- REHABILITATE DISTURBED SOIL BEHIND THE KERB BY SPREADING 20-25mm THICK LAYER OF TOPSOIL AND BROADCAST SEED MIX AT A RATE OF 0.3kg/10m2, UNLESS SPECIFIED OTHERWISE, TO DISTURBED AREAS WHERE TURF HAS NOT BEEN INSTALLED. SEEDS SHOULD BE SCRATCHED INTO THE SURFACE TO REDUCE THE INCIDENCE OF INGESTION BY BIRDS. IF SEED MIX DOES NOT INCLUDE STARTE FERTILISER, APPLY FERTILISER AT A RATE AS

KERBSIDE TURF STRIP SD 6-13

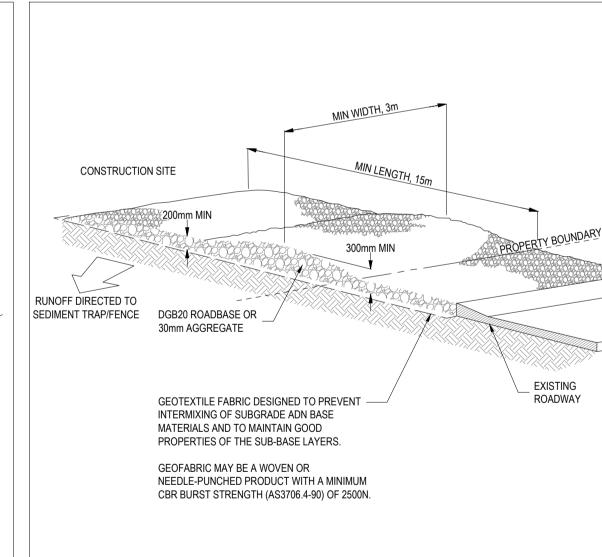

CONSTRUCTION NOTES:

- . STRIP THE TOPSOIL, LEVEL THE SITE AND COMPACT THE SUBGRADE.
- COVER THE AREA WITH NEEDLE-PUNCHED GEOTEXTILE.
- CONSTRUCTION A 200mm THICK PAD OVER THE GEOTEXTILE USING ROAD BASE OR 30mm AGGREGATE.
- ENSURE THE STRUCTURE IS AT LEAST 15 METRES LONG OR TO BUILDING ALIGNMENT AND AT LEAST 3 METRES WIDE.
- WHERE A SEDIMENT FENCE JOINS ONTO THE STABILISED ACCESS, CONSTRUCT A HUMP IN THE STABILISED ACCESS

TO DIVERT WATER TO THE SEDIMENT FENCE.

STABLISED SITE ACCESS SD 6-14

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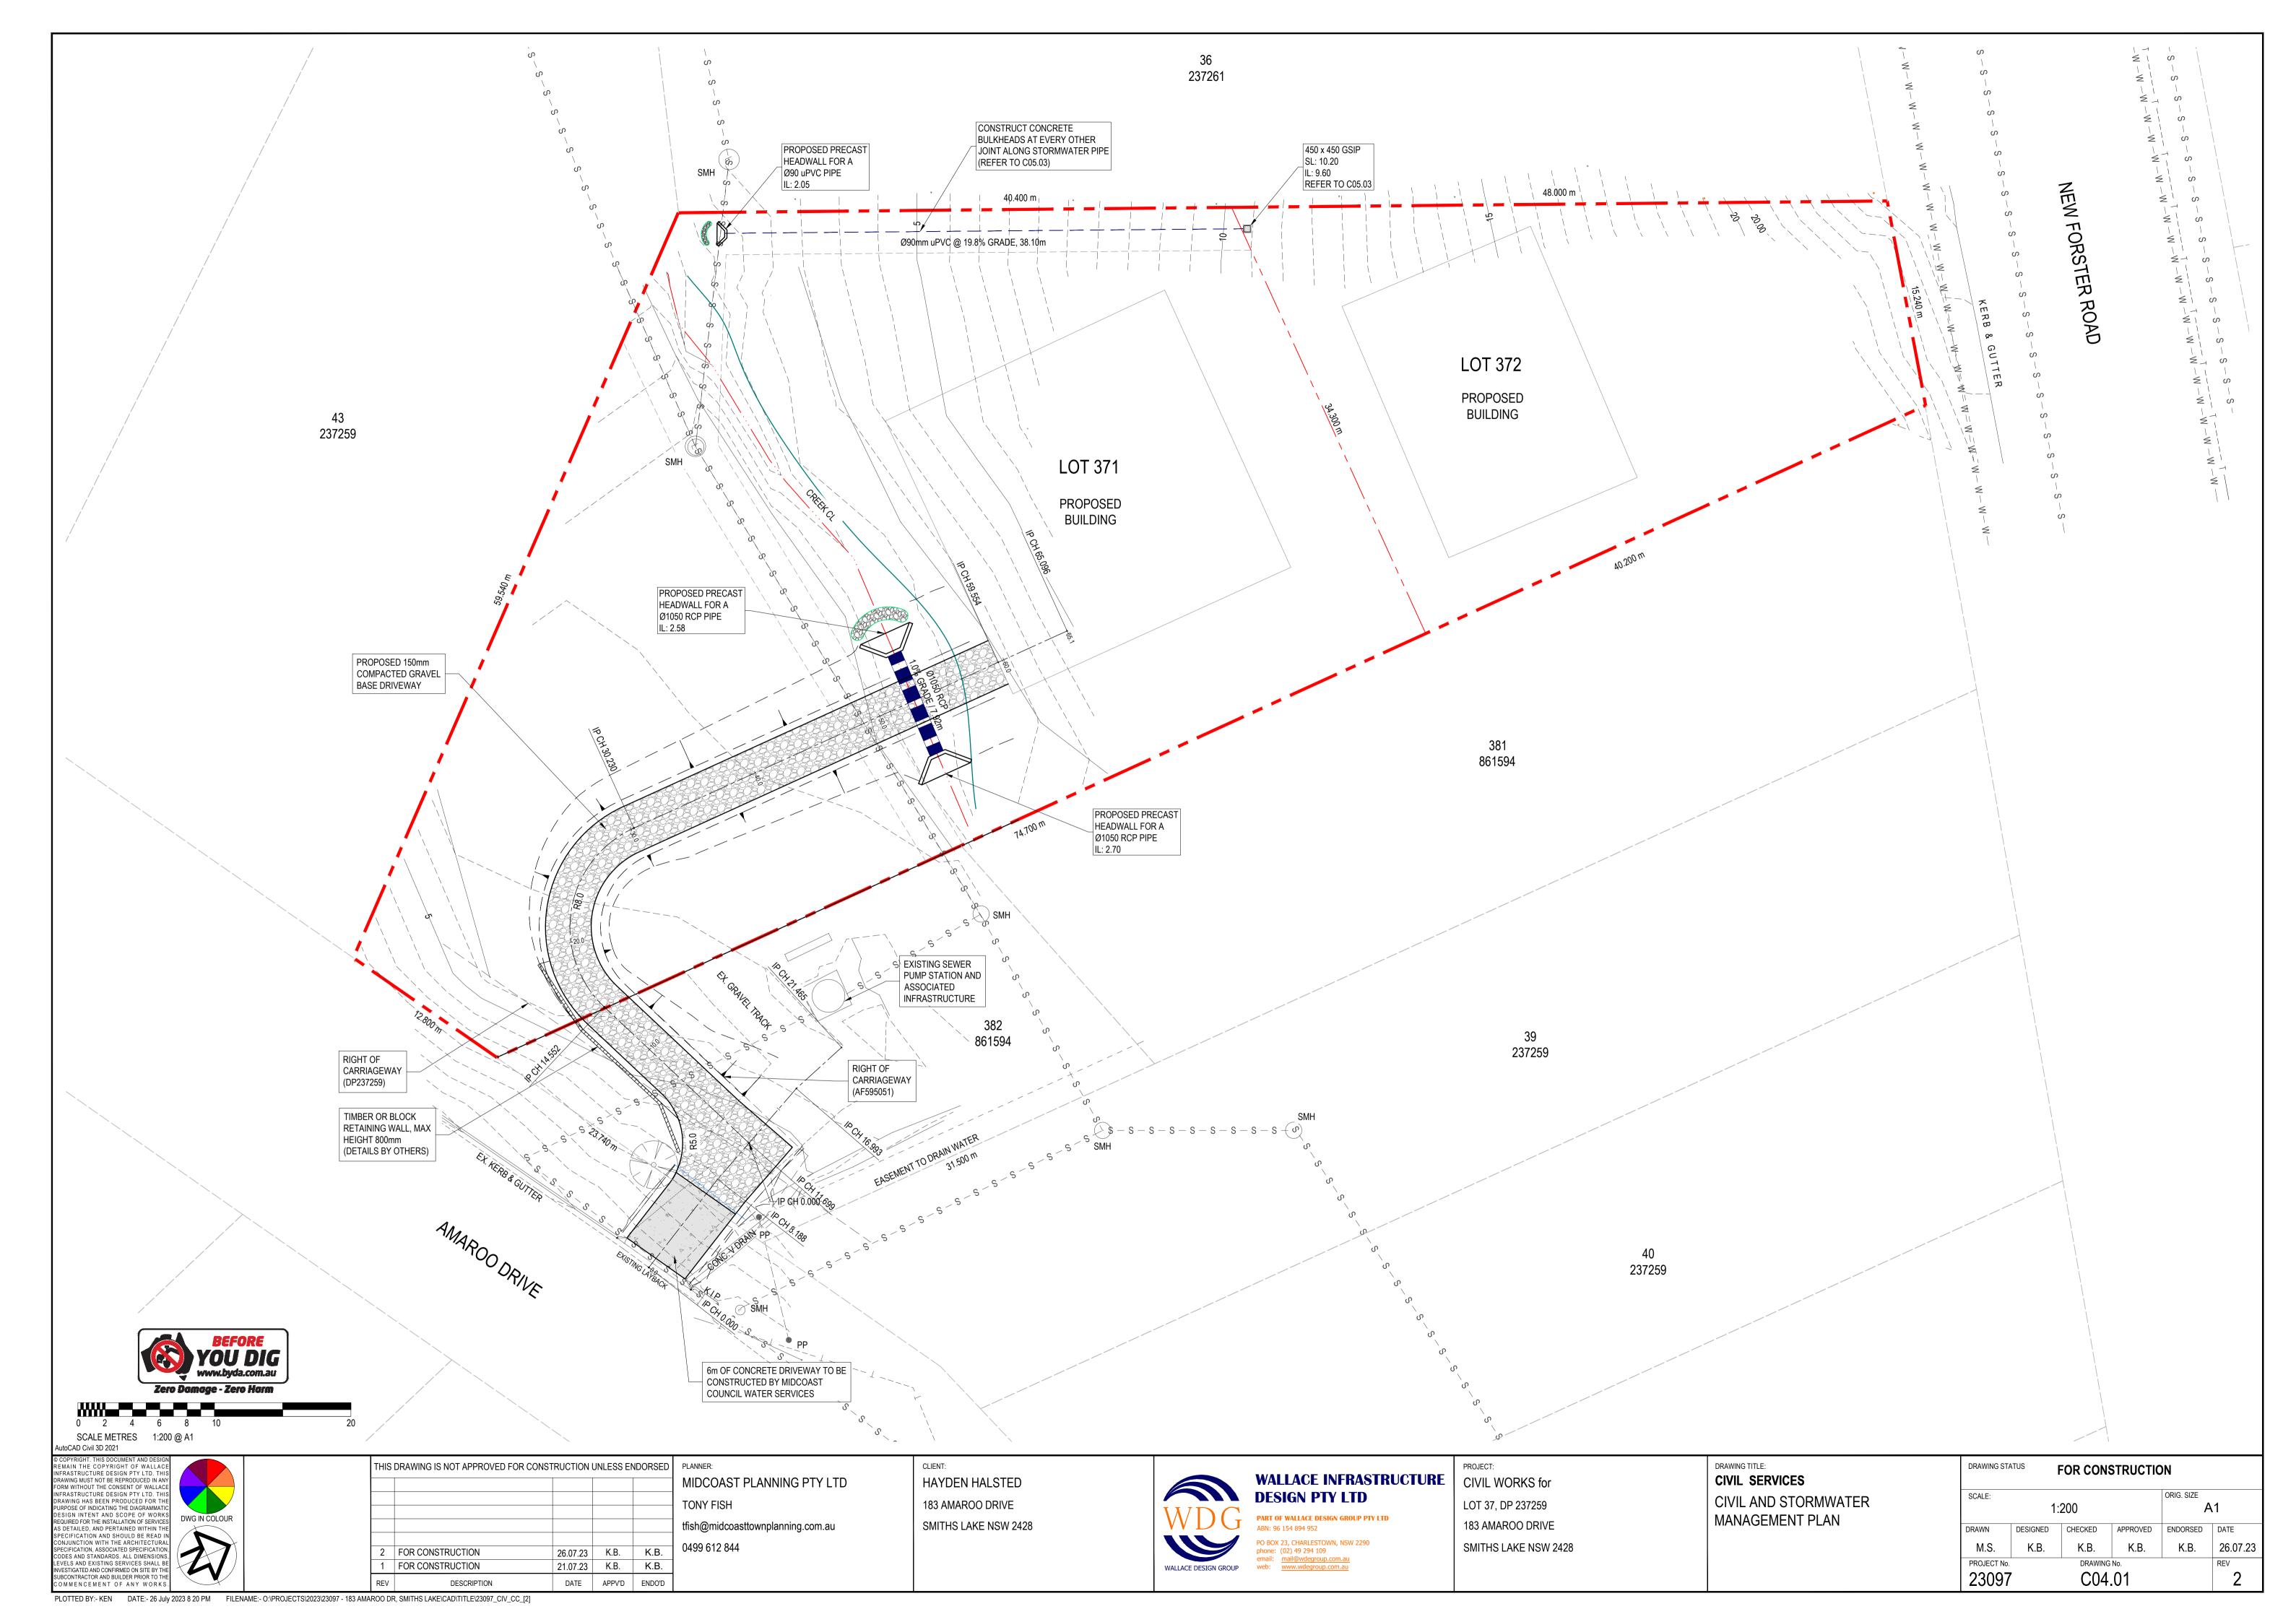
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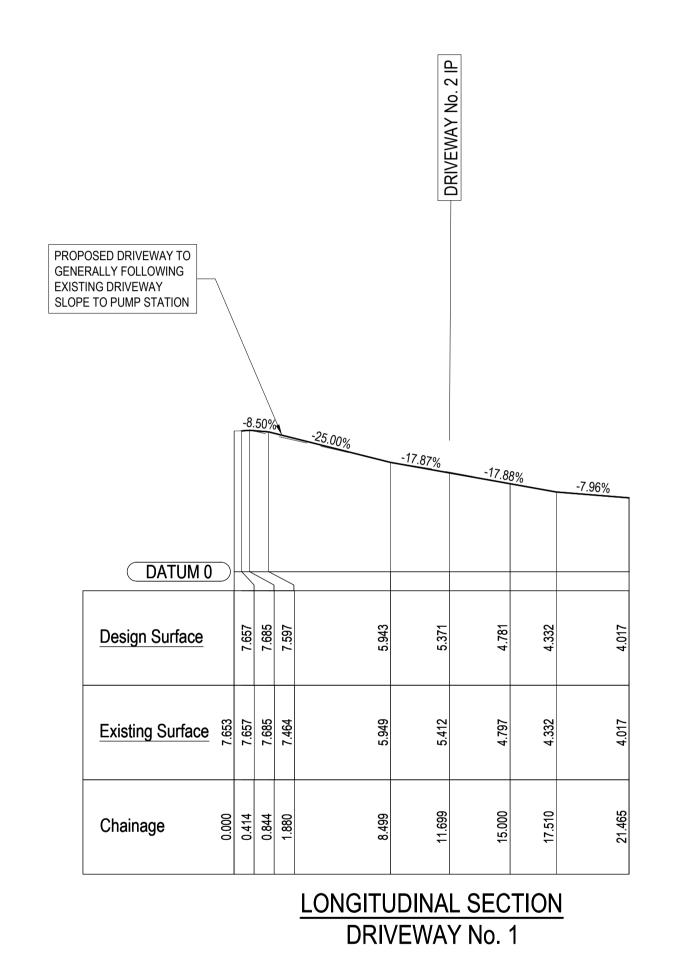



LOT 37, DP 237259 183 AMAROO DRIVE SMITHS LAKE NSW 2428

DRAWING TITLE: CIVIL SERVICES **EROSION AND SEDIMENTATION** CONTROL DETAILS

FOR CONSTRUCTION ORIG. SIZE SCALE: Α1 DRAWN DESIGNED CHECKED APPROVED ENDORSED DATE K.B. K.B. PROJECT No. 23097 C03.02





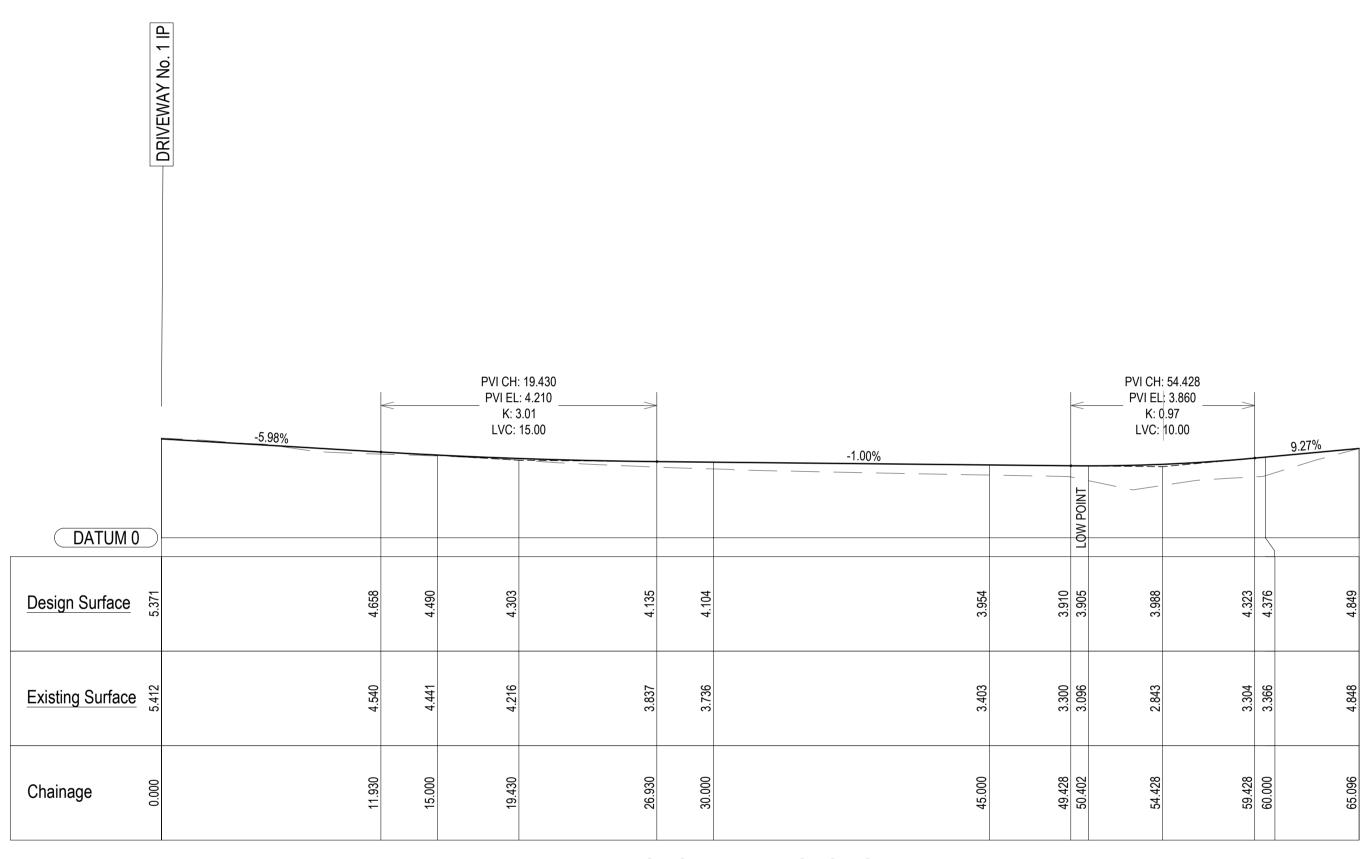

LONGITUDINAL SECTION DRIVEWAY No. 2

SCALE METRES 1:200 @ A1

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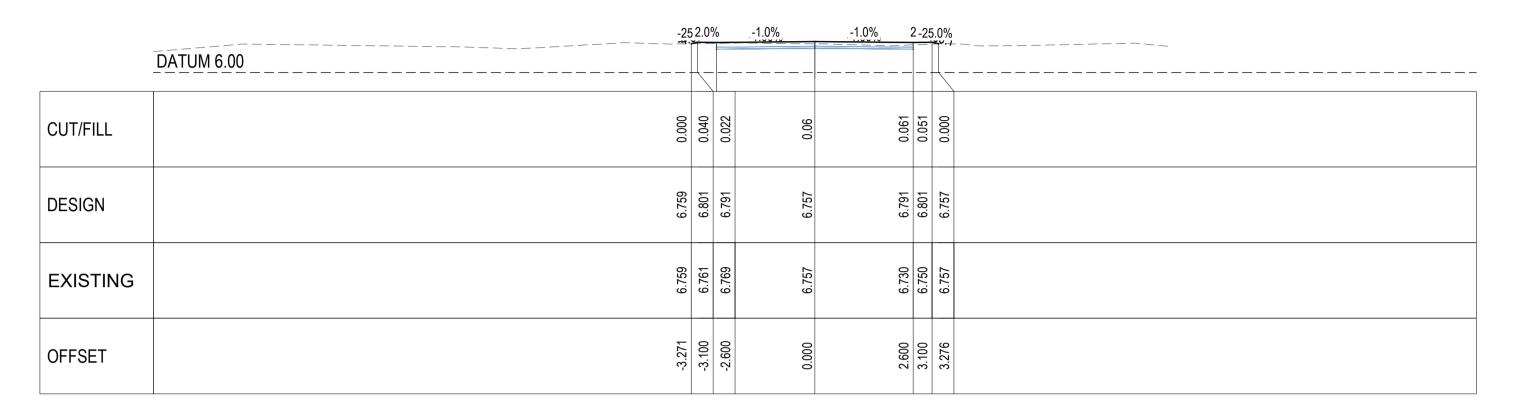
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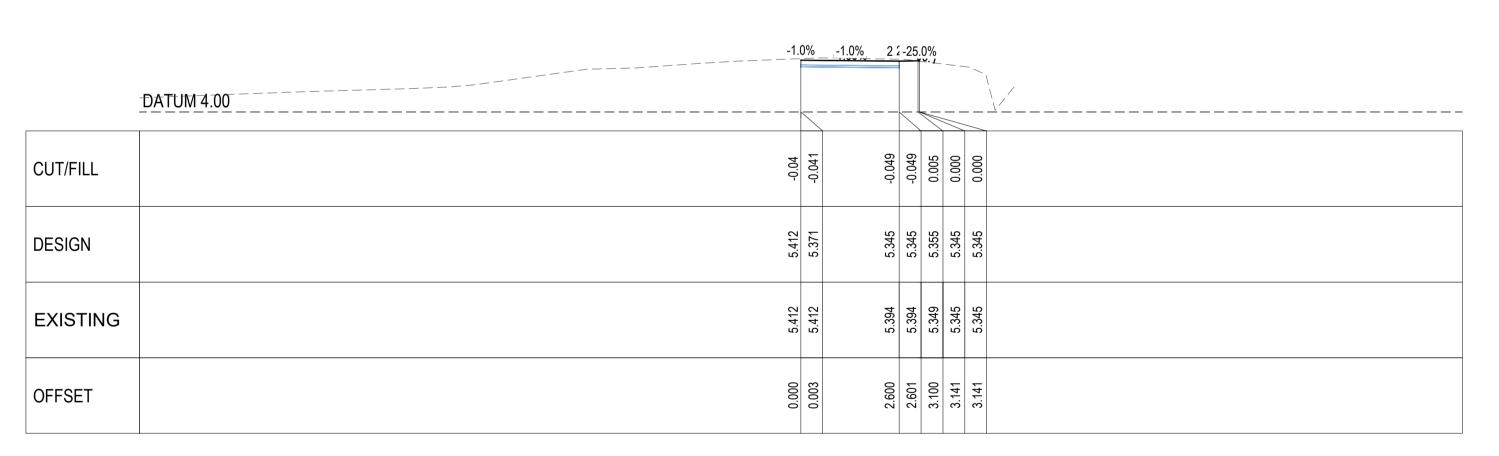
PROJECT: LOT 37, DP 237259 183 AMAROO DRIVE SMITHS LAKE NSW 2428

DRAWING TITLE: CIVIL SERVICES DRIVEWAY No.1 & No. 2 LONGITUDINAL SECTION


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CH 5.00



CH 11.70



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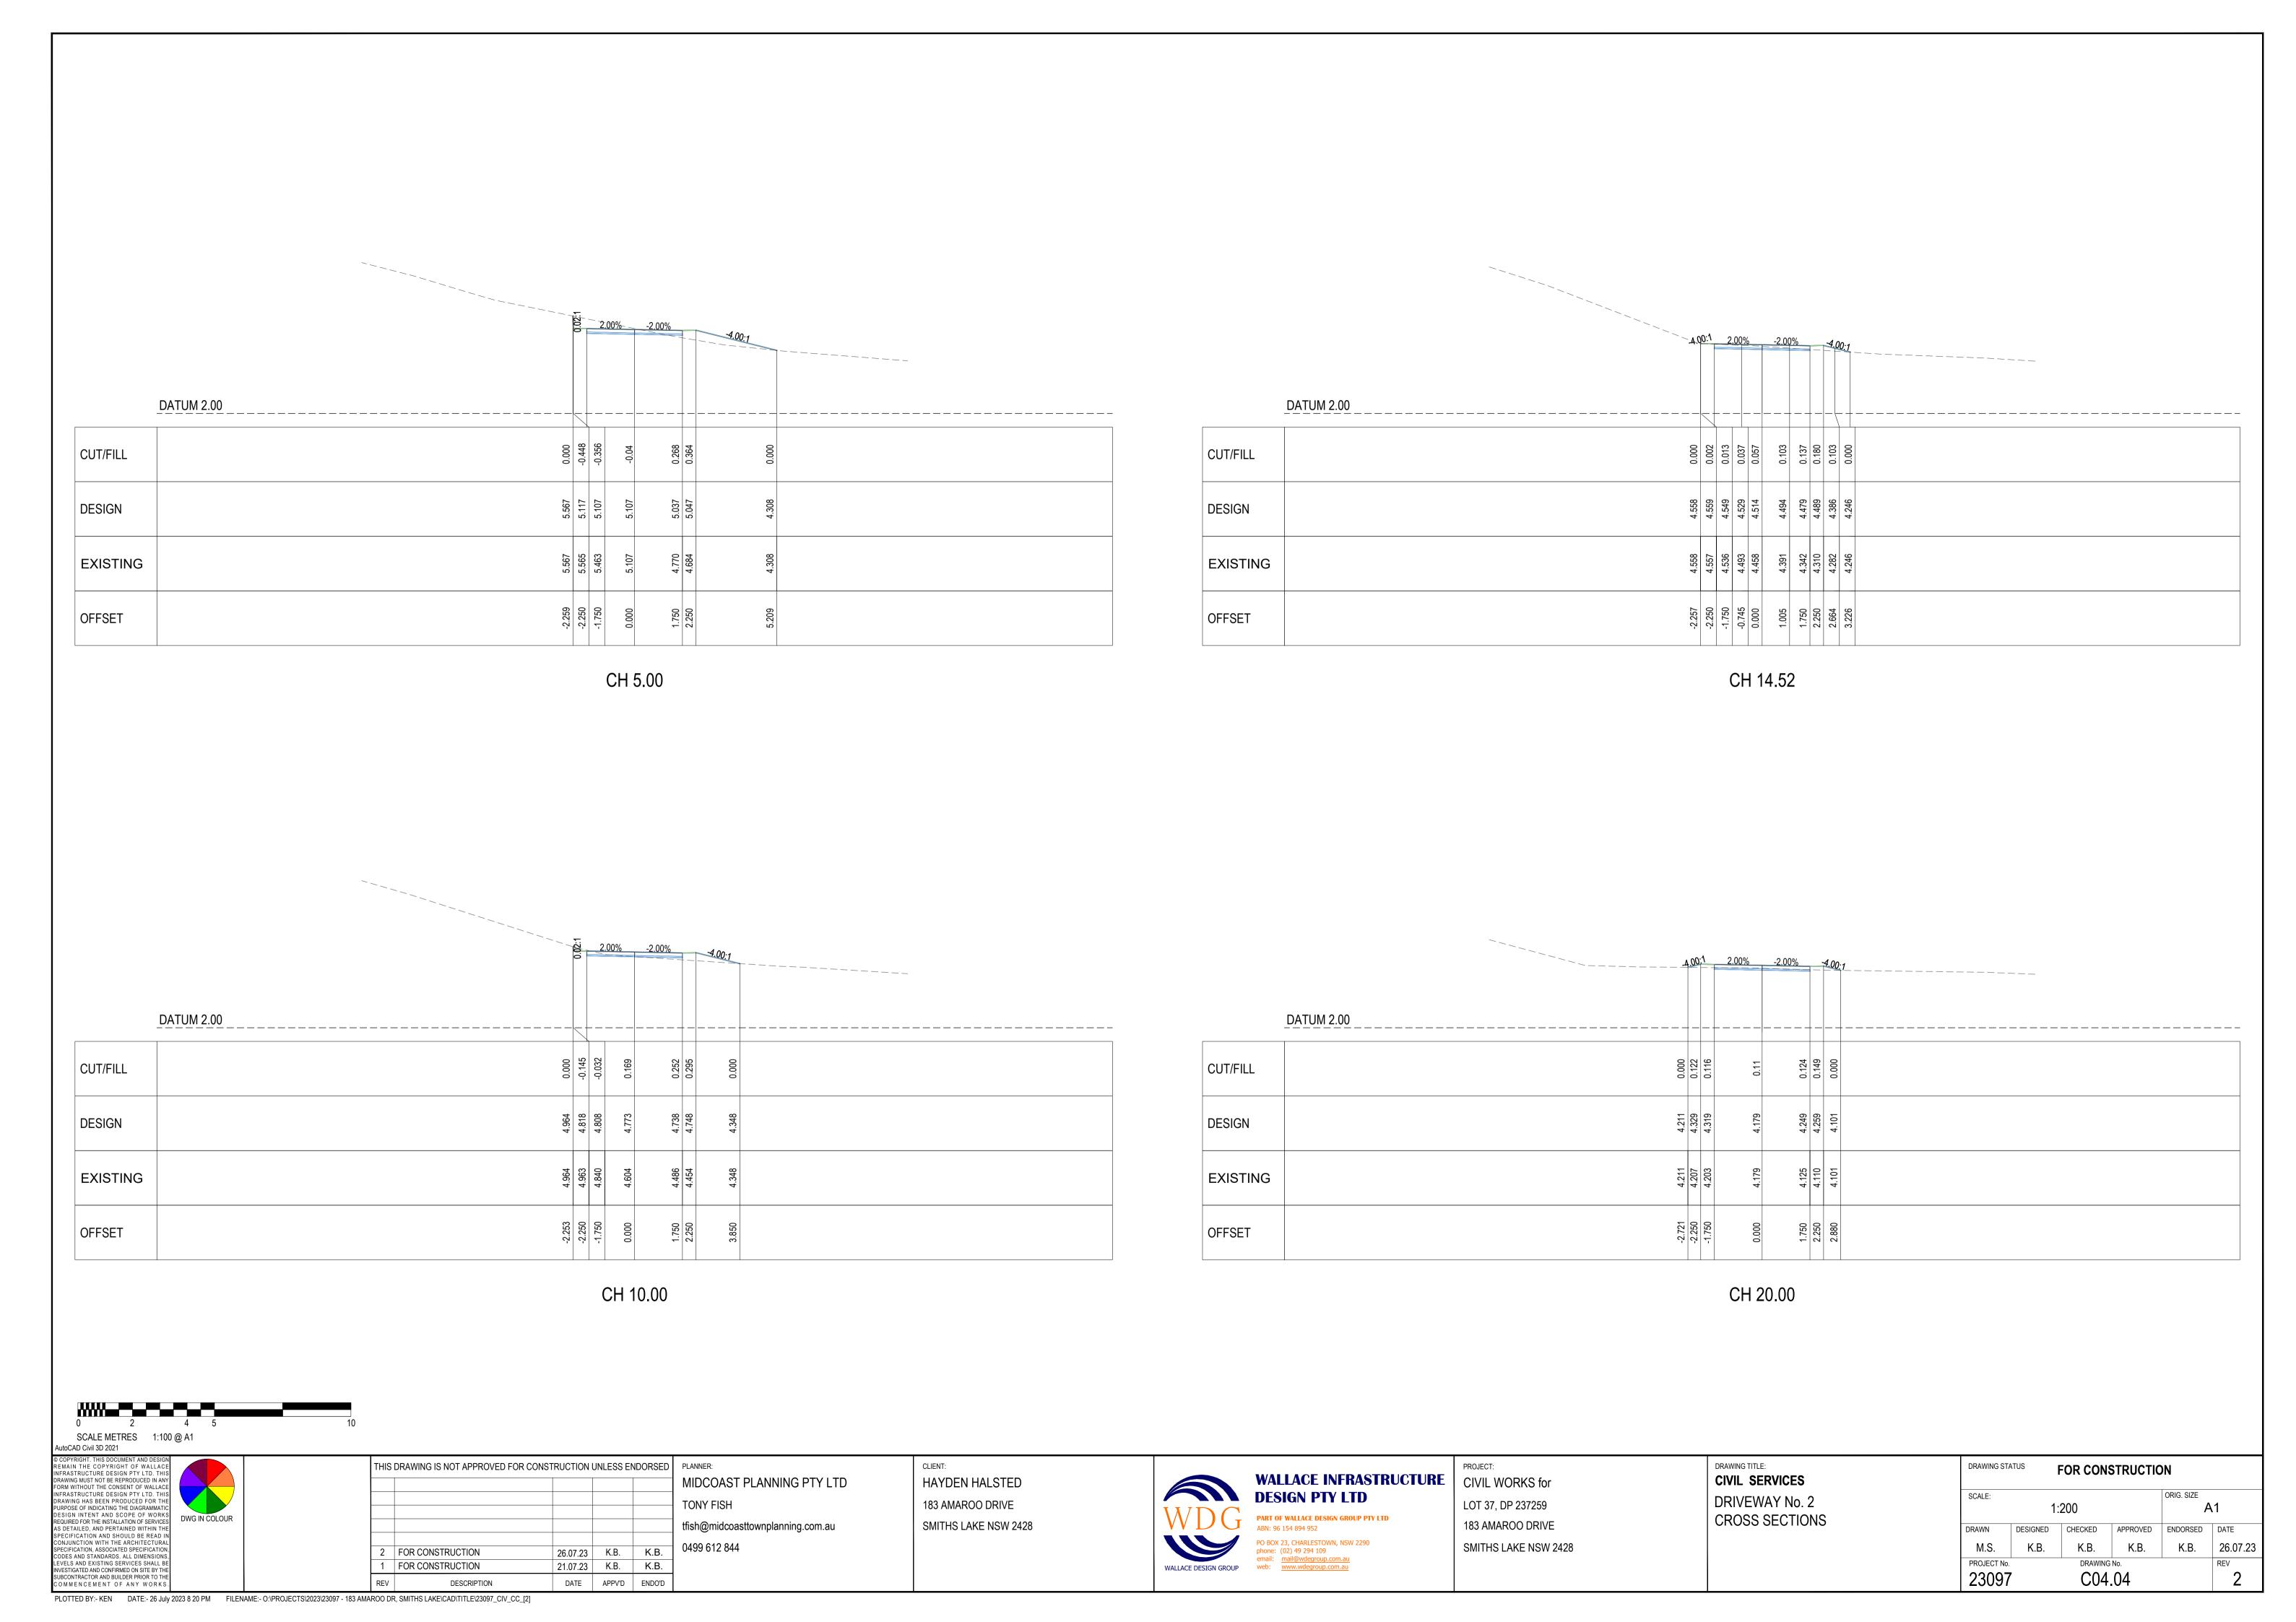
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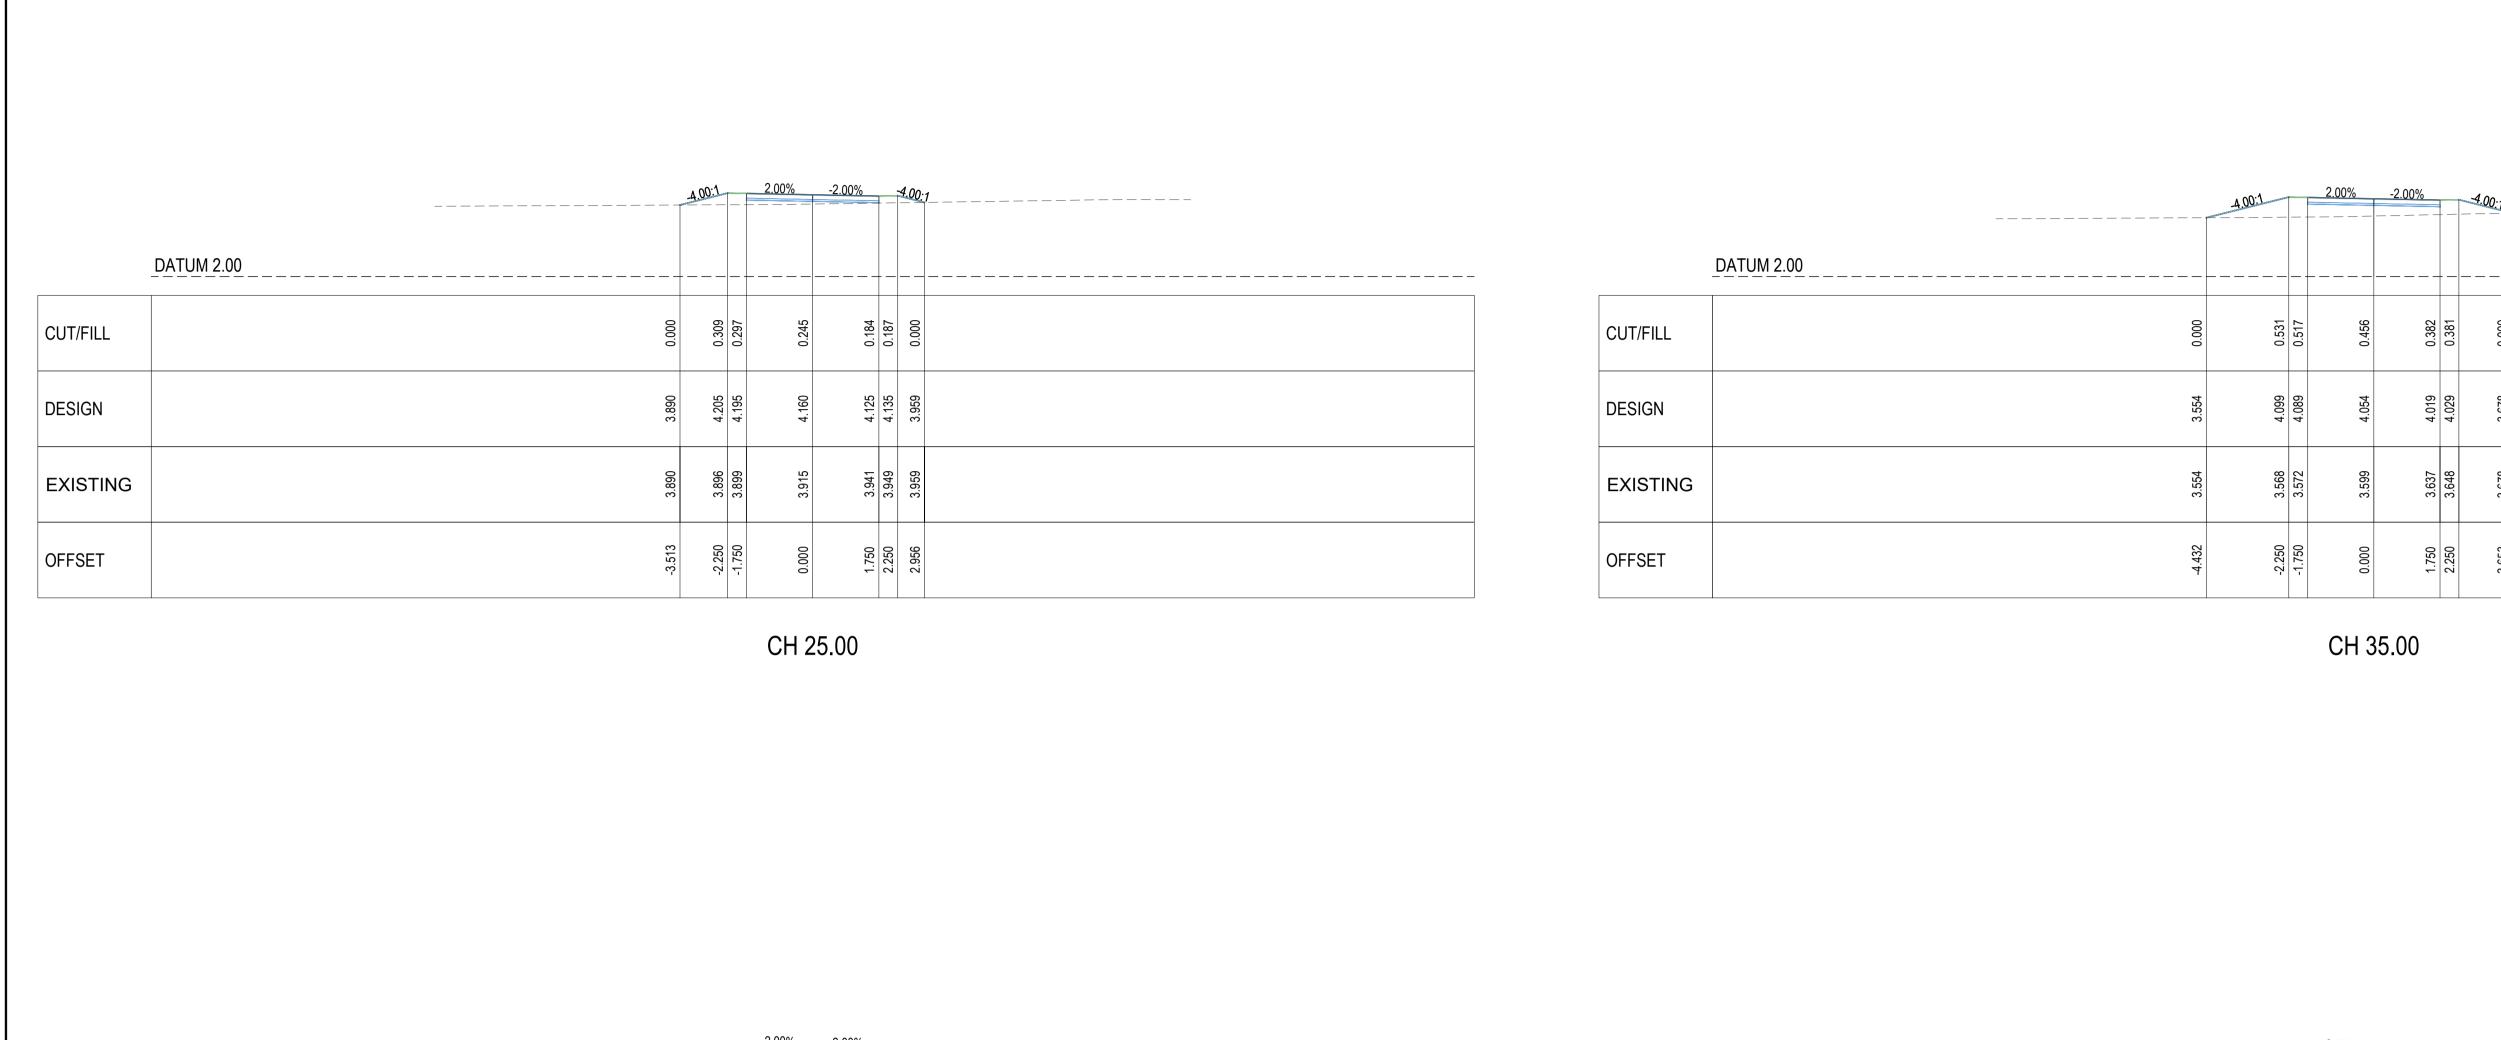


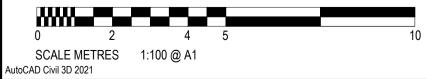
PROJECT: LOT 37, DP 237259 183 AMAROO DRIVE SMITHS LAKE NSW 2428

DRAWING TITLE: CIVIL SERVICES DRIVEWAY No. 1 CROSS SECTIONS

DRAWING STATUS FOR CONSTRUCTION ORIG. SIZE SCALE: 1:200 Α1 DESIGNED CHECKED APPROVED ENDORSED DATE DRAWN M.S. K.B. K.B. K.B. 26.07.23 DRAWING No. PROJECT No. 23097 C04.03





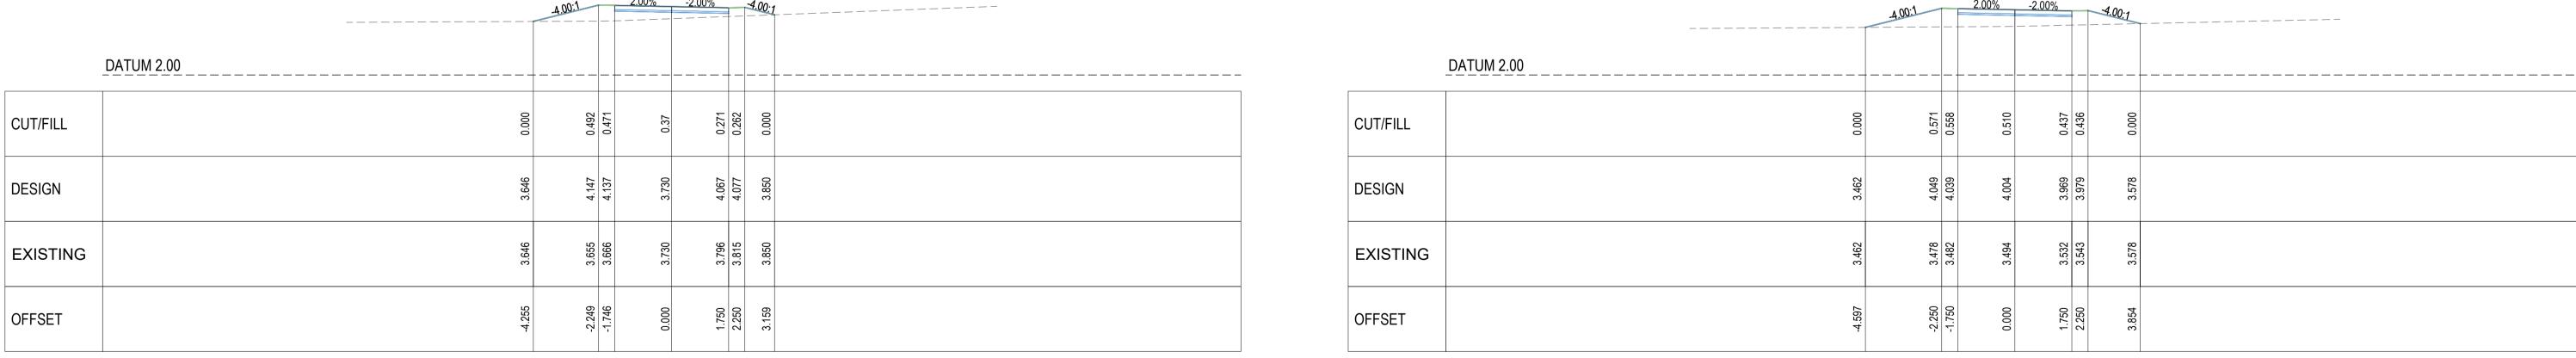

CH 30.23 CH 40.00

SCALE METRES 1:100 @ A1 AutoCAD Civil 3D 2021

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PROJECT:

DRAWING TITLE: CIVIL SERVICES DRIVEWAY No. 2 **CROSS SECTIONS**

DRAWING STATUS FOR CONSTRUCTION ORIG. SIZE SCALE: 1:200 Α1 DESIGNED CHECKED APPROVED ENDORSED DATE DRAWN M.S. K.B. K.B. K.B. 26.07.23 PROJECT No. DRAWING No. 23097 C04.05


	<u>400:1</u>		2.00%	-2.00%	-4.00:1	\
DATUM 2.00						
CUT/FILL	00000	0.598	0.551	0.491	0.000	
DESIGN	3.371	3.999	3.954	3.929	3.478	
EXISTING	3.371	3.388	3.403	3.428	3.478	
OFFSET	4.765	-2.250	0.000	1.750	4.055	

		4.00:1	2.00%	-2.00%	4.00:1	
	DATUM 2.00					
CUT/FILL	0000	1.073	696.0	0.894	0000	
DESIGN	3.087	4.209	4.164	4.129	3.322	
EXISTING	3.087	3.136	3.195	3.235	3.322	
OFFSET	-6.737	-2.250	0000	1.750	5.517	

CH 45.00 CH 57.50

		4.00:1		2.00% -2.00)%	4.00:1
	DATUM 2.00					. – – – – – – – – – – – – – – – – – – –
CUT/FILL		0.000	0.710	0.726	0.717	0.000
DESIGN		3.268	3.951	3.906	3.871	3.247
EXISTING		3.268	3.241	3.180	3.154	3.247
OFFSET		4.982	-2.250	0.000	1.750	4.787

CH 50.00

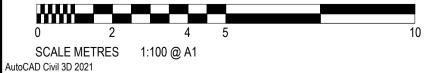

AutoCAD Civil 3D 2021

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MIDCOAST PLANNING PTY LTD TONY FISH tfish@midcoasttownplanning.com.au


HAYDEN HALSTED 183 AMAROO DRIVE SMITHS LAKE NSW 2428




LOT 37, DP 237259 183 AMAROO DRIVE SMITHS LAKE NSW 2428

DRAWING TITLE: CIVIL SERVICES DRIVEWAY No. 2 CROSS SECTIONS

DRAWING STATUS FOR CONSTRUCTION ORIG. SIZE SCALE: 1:200 A1 DRAWN DESIGNED CHECKED APPROVED ENDORSED DATE K.B. M.S. K.B. K.B. 26.07.23 PROJECT No. DRAWING No. 23097 C04.06

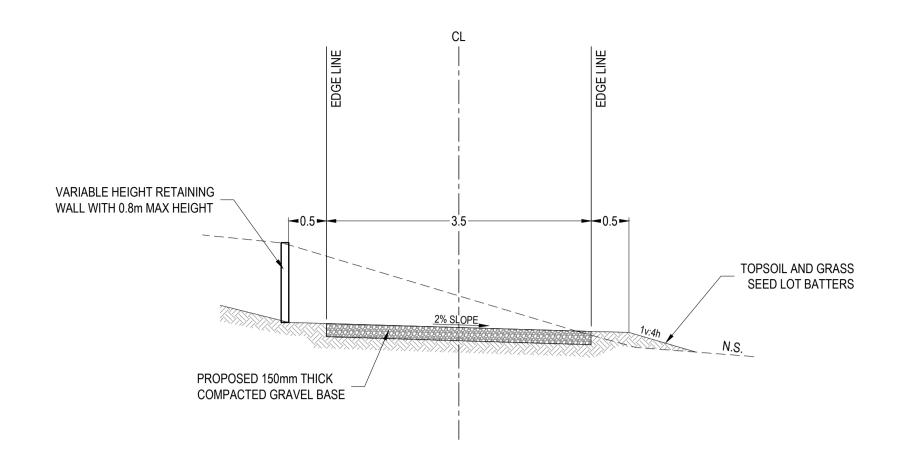

TYPICAL 3.5m DRIVEWAY No.2 -CH 0.000 TO 19.500 1:50

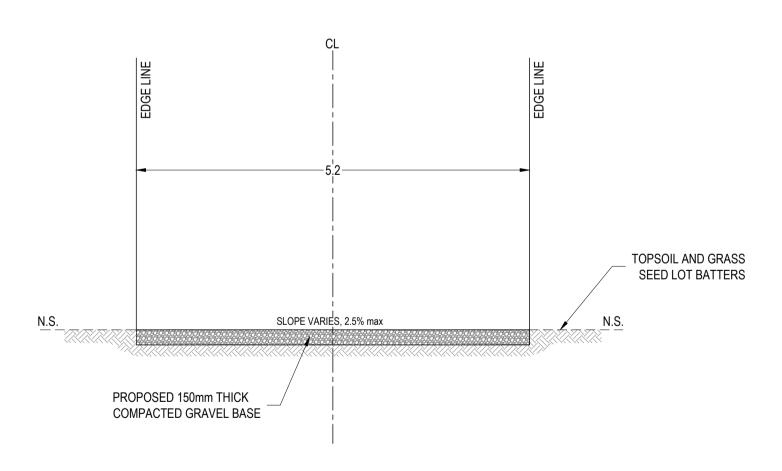

DRIVEWAY No.1 TYPICAL SECTION



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HAYDEN HALSTED 183 AMAROO DRIVE SMITHS LAKE NSW 2428



LOT 37, DP 237259 183 AMAROO DRIVE SMITHS LAKE NSW 2428

2% SLOPE

TYPICAL 3.5m DRIVEWAY No.2 -

CH 19.500 TO END

1:50

PROPOSED 150mm THICK COMPACTED GRAVEL BASE 2% SLOPE

DRAWING TITLE: CIVIL SERVICES DRIVEWAY TYPICAL SECTIONS

TOPSOIL AND GRASS SEED LOT BATTERS

> DRAWING STATUS FOR CONSTRUCTION ORIG. SIZE SCALE: Α1 DESIGNED CHECKED APPROVED ENDORSED DATE DRAWN M.S. K.B. K.B. K.B. 26.07.23 PROJECT No. 23097 C05.01

